
APPENDIX A DESIGN DRAWINGS

Annacis Island WWTP New Outfall System

Vancouver Fraser Port Authority Project and Environmental Review Application

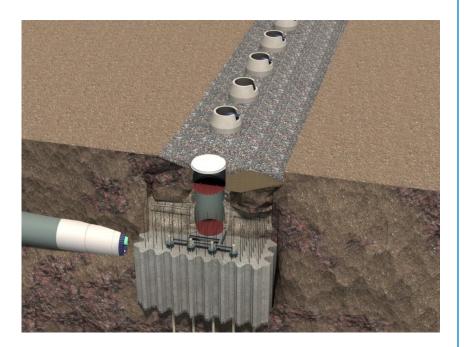



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metro vancouver

Greater Vancouver Regional District • Greater Vancouver Water District

Greater Vancouver Sewerage and Drainage District • Greater Vancouver Housing Corporation

4330 Kingsway, Burnaby, BC, Canada V5H 4G8 604-432-6200

GREATER VANCOUVER SEWER AND DRAINAGE DISTRICT

ANNACIS ISLAND WASTEWATER TREATMENT PLANT NEW OUTFALL SYSTEM CONSTRUCTION SERVICES FOR THE OUTFALL

RFP NO. 18-0001


ISSUED FOR PERMIT DRAWING SET

NOVEMBER 2017


www.metrovancouver.org


SHEET INDEX

DFN: SF-1933	TEMPORARY DWG. NO.	DRAWING TITLE
GENERAL		
	A00 X-G001	COVER SHEET
	A00 X-G003	DRAWING INDEX - 1
	A10G0031	GENERAL LOCATION AND VICINITY MAP
	A10 X-G001	HYDRAULIC PROFILE NEW OUTFALL SYSTEM
	A10 X-G0101	A10 – GENERAL SITEWORKS NOS AERIAL MAP
SITE PLAN AND BUILDINGS, STRUCTURES & EQUIPMENT, AND LOT GRADING & UTILITIES		
	A10 X-C0101	RIGHT OF WAY KEY PLAN
	X-A61C0028	LOT 236 PLAN AND ISOMETRIC
	X-A61C0029	LOT 187 PLAN AND ISOMETRIC
	X-A61C0030	PLAN LOT 179 VOLUMETRIC RIGHT OF WAY
	X-A61C0031	WATER FRONT LOT PLAN
	A61C0001	A61 – GENERAL SITE WORKS, NOS SITE PLAN KEY MAP
	A61C0002	A61 – TUNNEL PLAN & PROFILE 1
	A61C0003	A61 – TUNNEL PLAN & PROFILE 2
	A61C0004	A61 – TUNNEL PLAN & PROFILE 3
	A61C0005	A61 – TUNNEL PLAN & PROFILE 4
	X-A10C007	CIVIL WORKS - GENERAL SITE CONSTRUCTION ACCESS AND STAGING
	X-A10C008	CIVIL WORKS – OUTFALL SHAFT SITE CONSTRUCTION ACCESS AND STAGING
	X-A61S0081	RIVER RISER CONSTRUCTION SEQUENCE 1
	X-A61S0082	RIVER RISER CONSTRUCTION SEQUENCE 2
	X-A61S0083	RIVER RISER CONSTRUCTION SEQUENCE 3
MARINE STRUCTURES		
	A61C0070	DIFFUSER MANIFOLD RIVER PLAN
	A61C0077	EXISTING OUTFALL PLAN
	A61C0078	EXISTING OUTFALL SECTION & DETAILS
	A61C0052	RIVER RISER PLAN TOP LEVEL
	A61C0053	RIVER RISER SECTION
	A61C0071	DIFFUSER MANIFOLD SECTION 1
	A61C0072	DIFFUSER MANIFOLD SECTION 2
	A61C0073	DIFFUSER MANIFOLD SECTION 3
	A61C0074	DIFFUSER MANIFOLD DETAILS
LIGHTING PLAN		
LIGHTING PLAN	A50E4721	LAYOUT LEVEL CONTROL STRUCTURE (LCS) AREA 50 – POWER AND LIGHTING PLAN

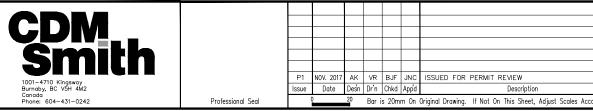


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	Design: <u>AK</u> Drawn: VR	ANNACIS ISLAND WWTP NEW OUTFALL SYSTEM	SCALE: NONE
	Drawn: <u>VR</u> Checked: <u>BJF</u>	CONSTRUCTION SERVICES FOR THE OUTF	ALL DISTRICT FILE S-1933
	JNC Approved		
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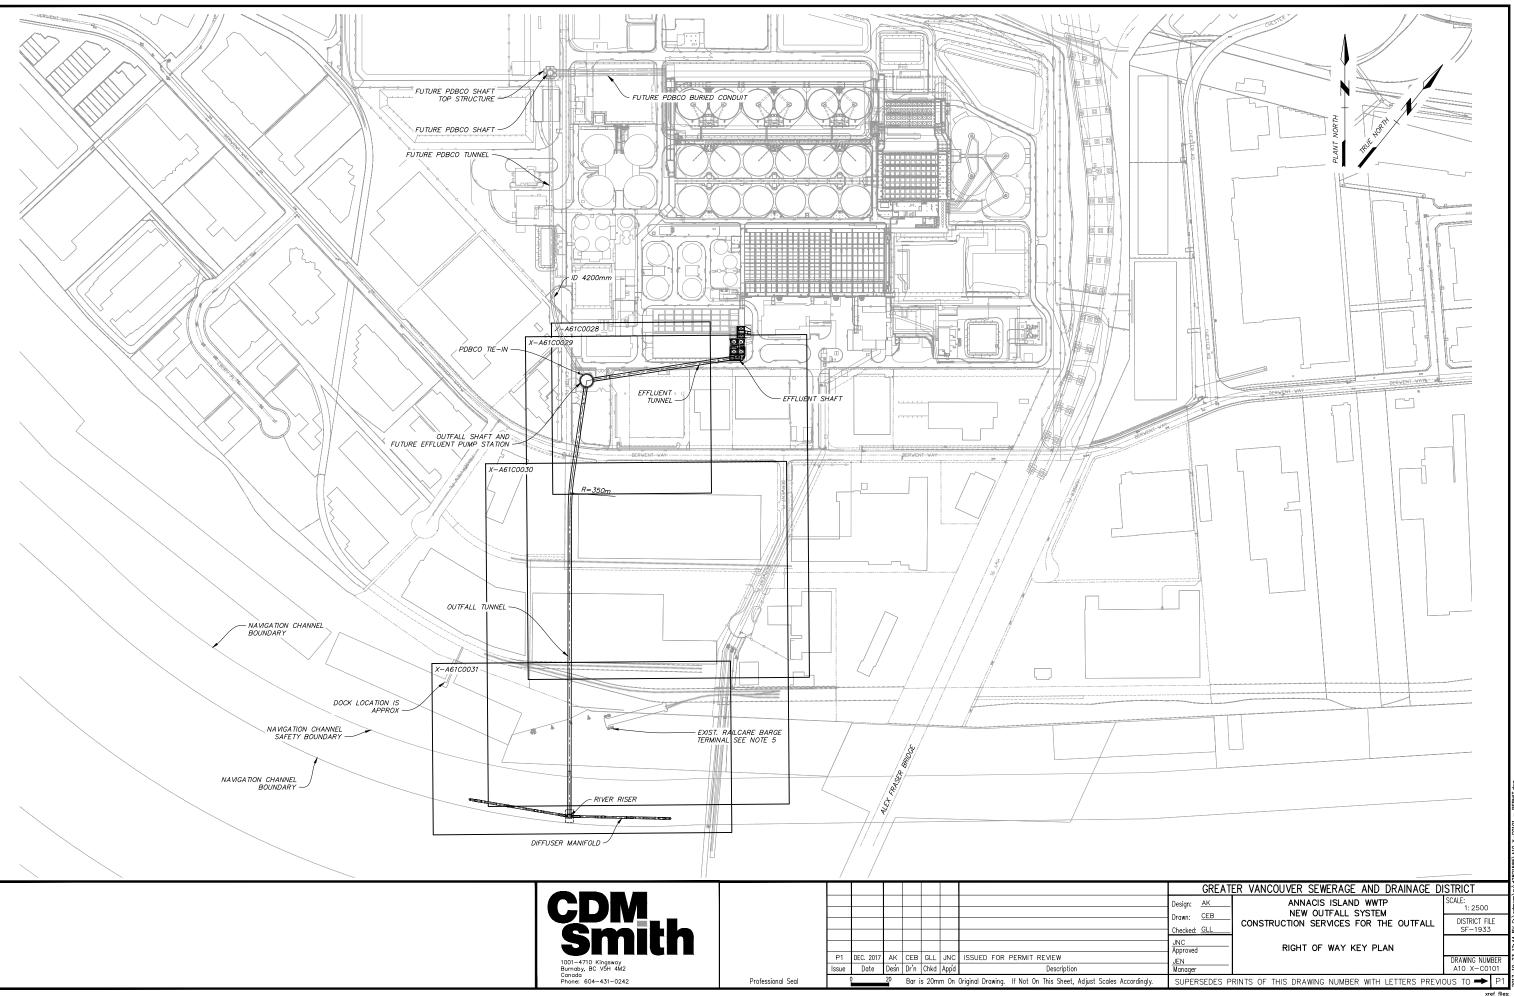


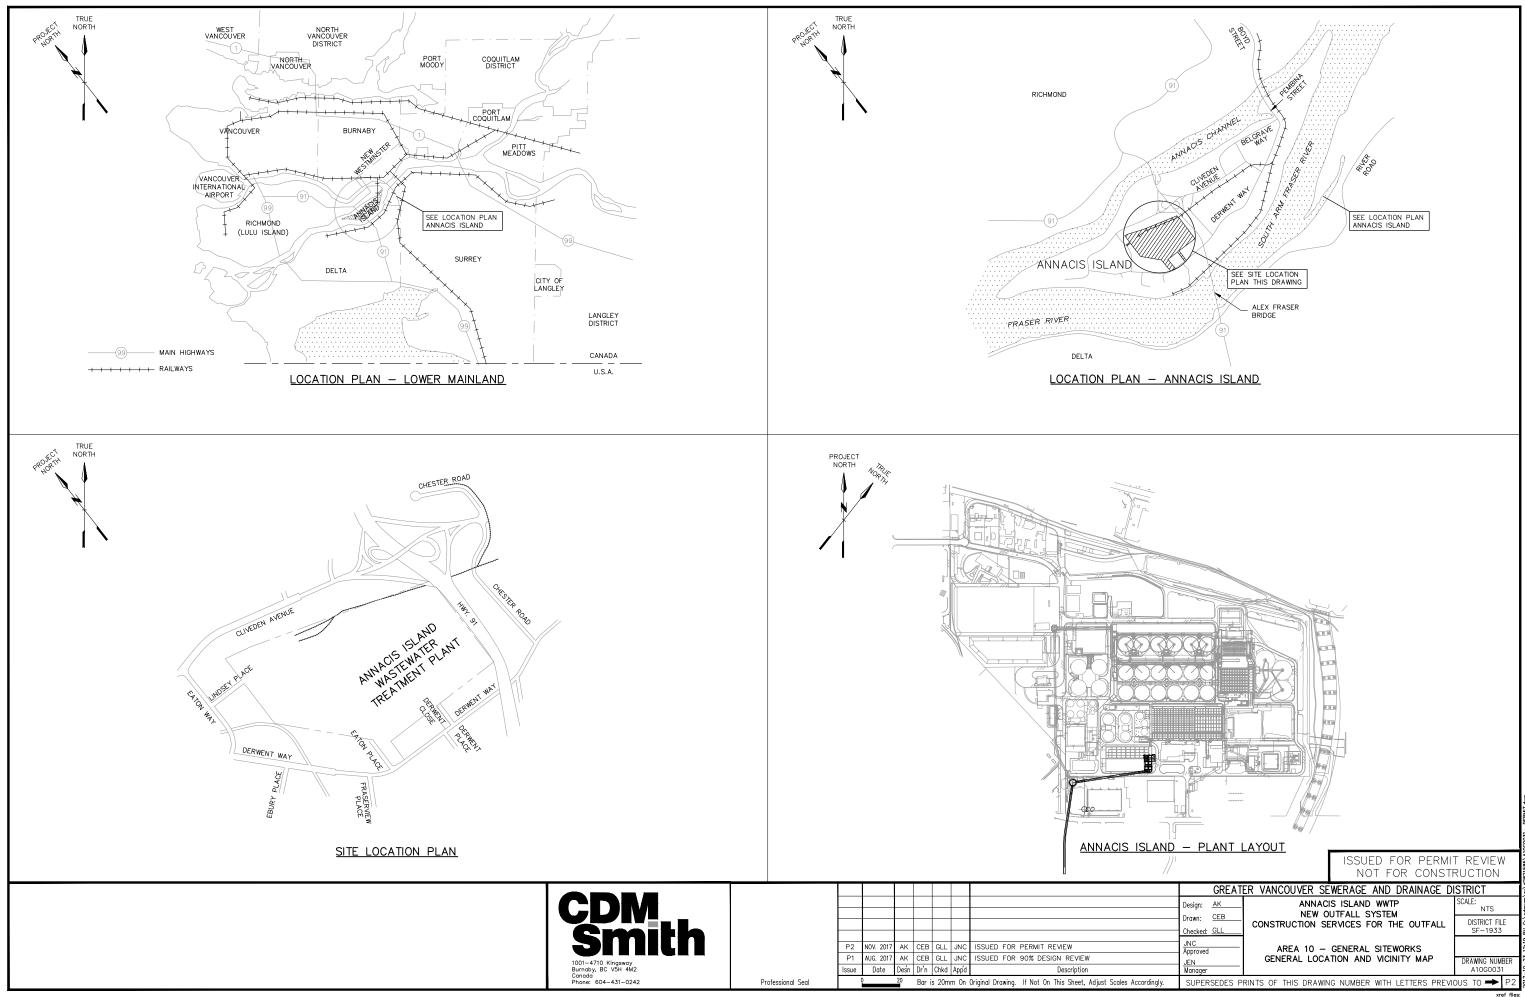


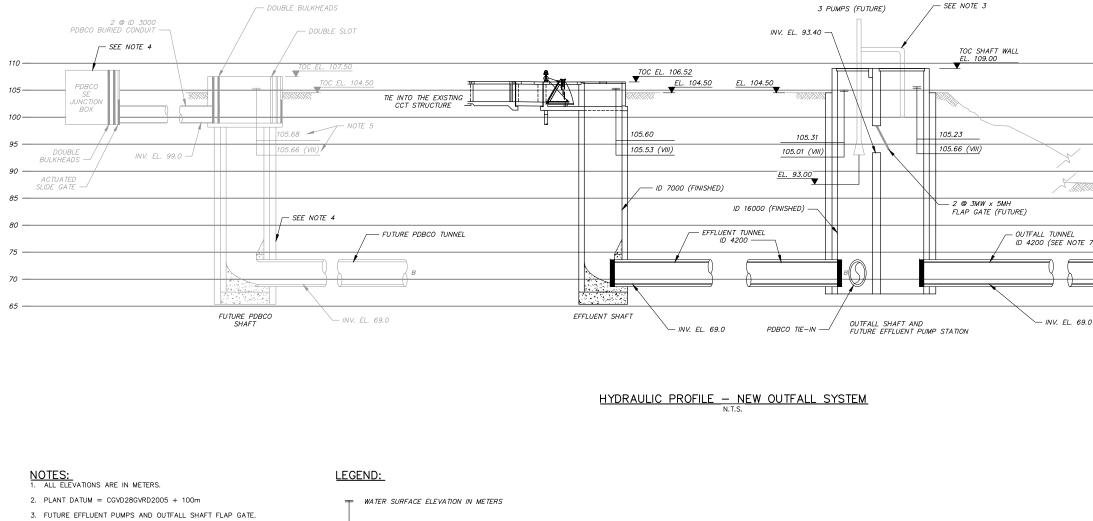
- PDBCO SHAFT, TUNNEL, BURIED CONDUIT AND SE JUNCTION BOX CONSTRUCTION TO FOLLOW AFTER NOS UNDER SEPARATE CONSTRUCTION CONTRACT.
- 5. ASSUMES FULL STAGE V AND STAGE VIII (WITH PUMPING) FLOWS THROUGH PDBCO.
- 6. TUNNEL 3820mm STEEL LINER, PE COATED NOT SHOWN.
- THE TOP OF THE SHAFTS ELEVATIONS INCLUDE 1.00m FOR GLOBAL SEA LEVEL RISE.


R WATER LEVEL
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DIFFUSER MANIFOLD
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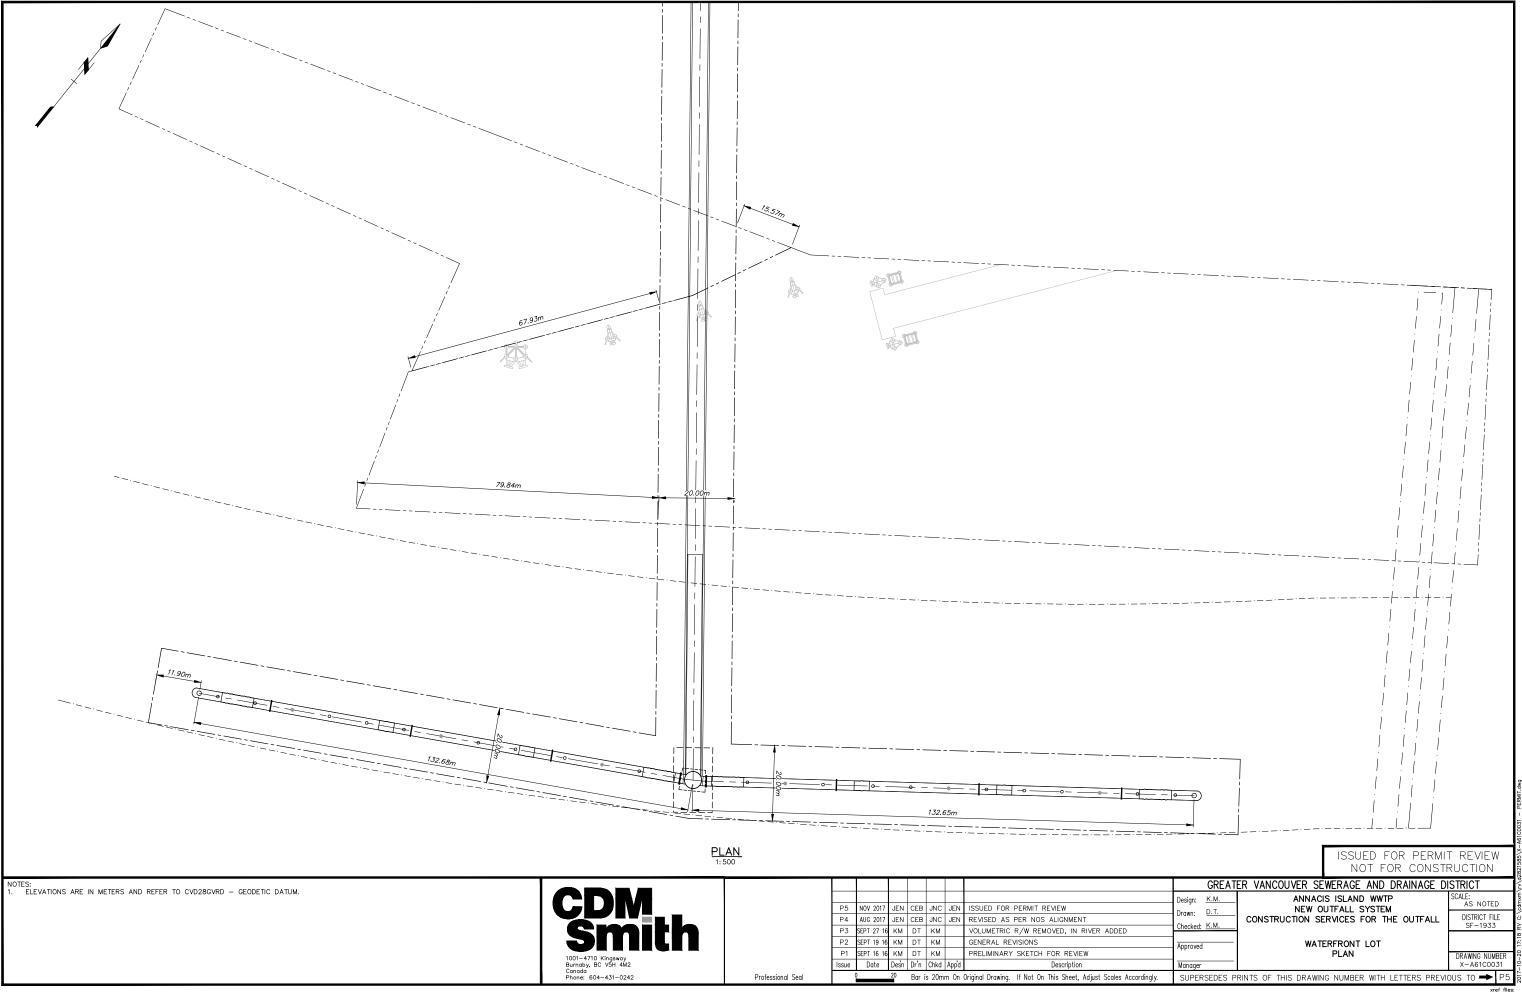





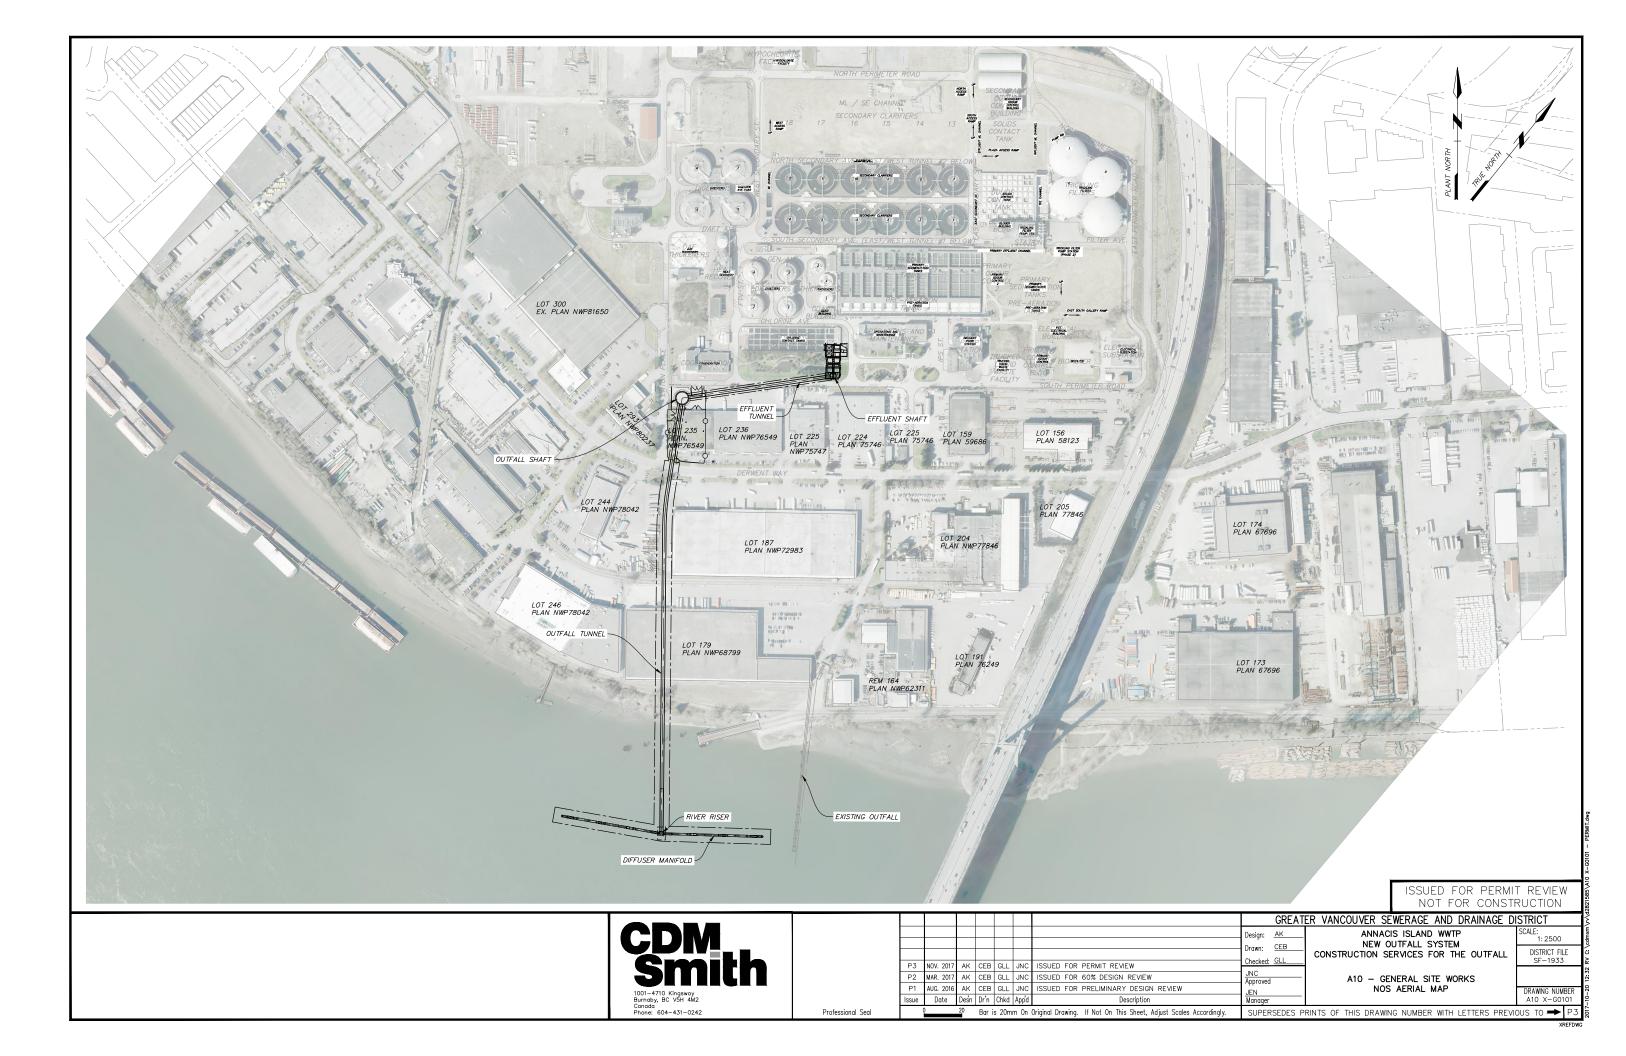


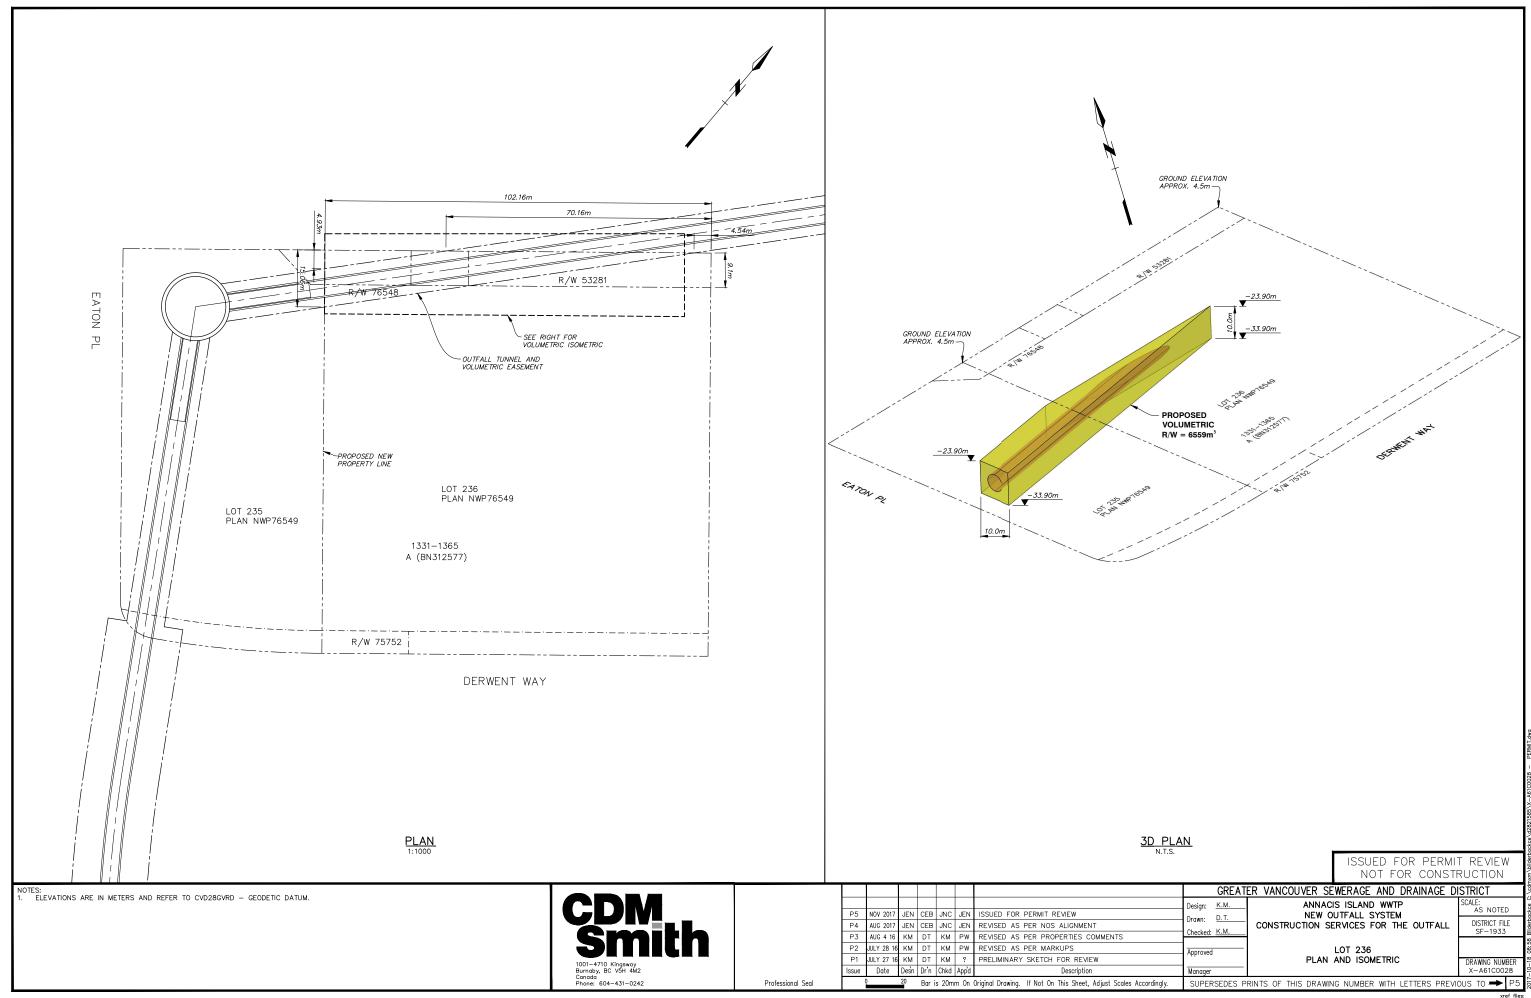


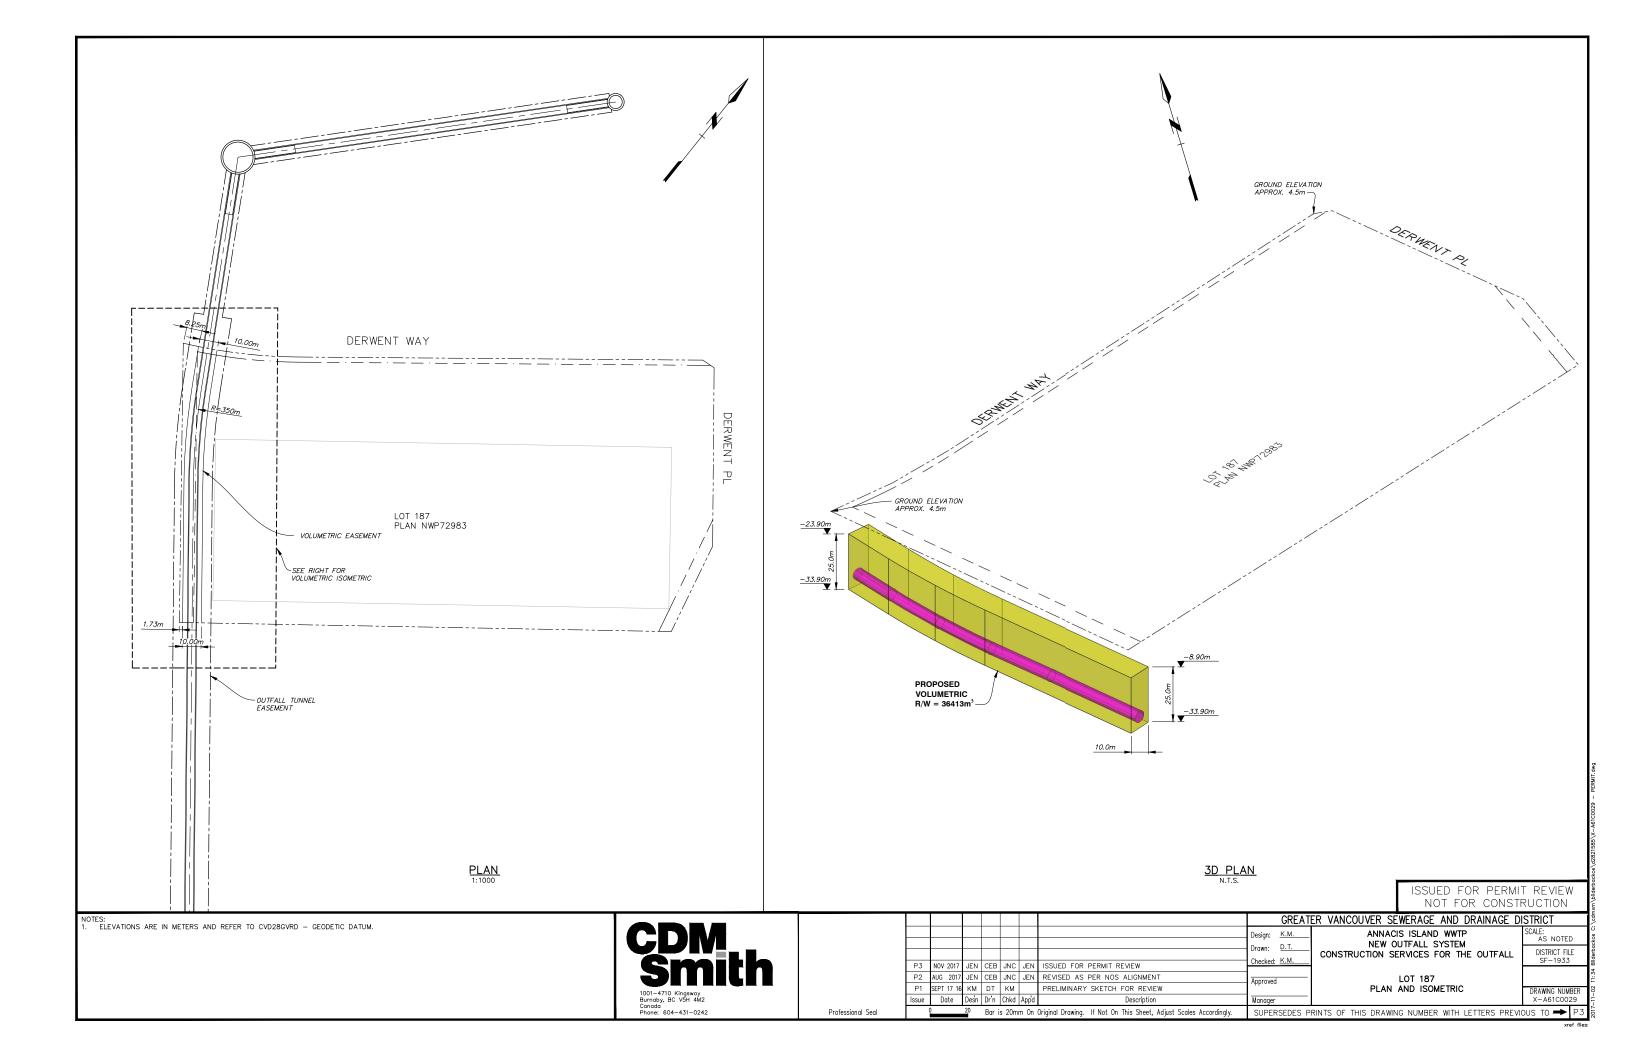

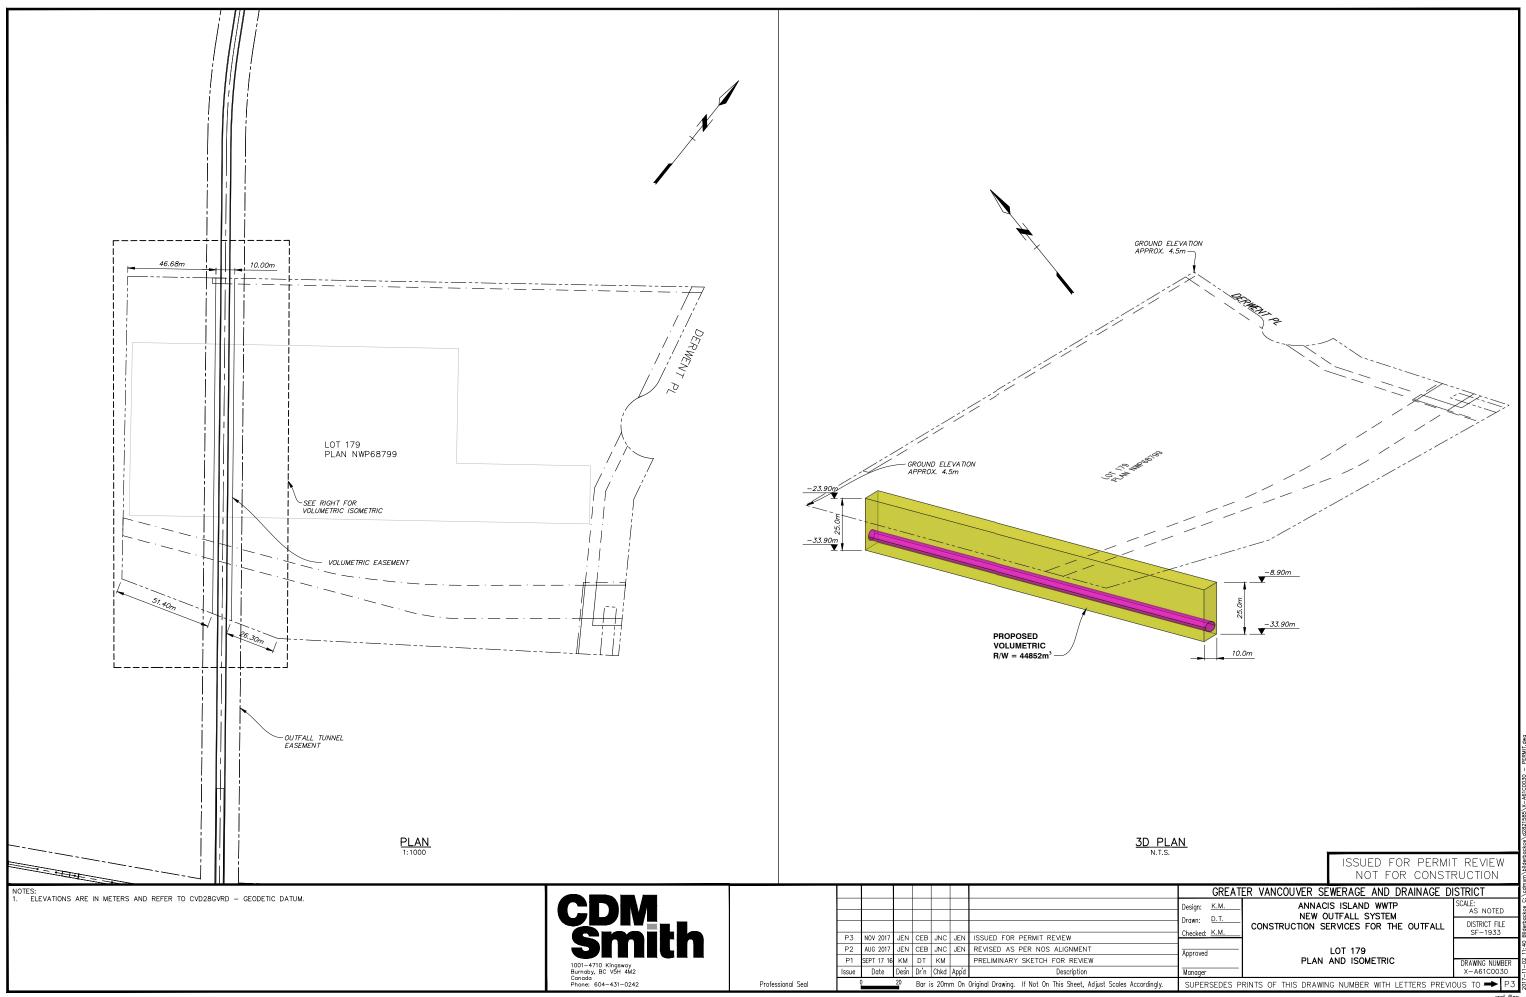

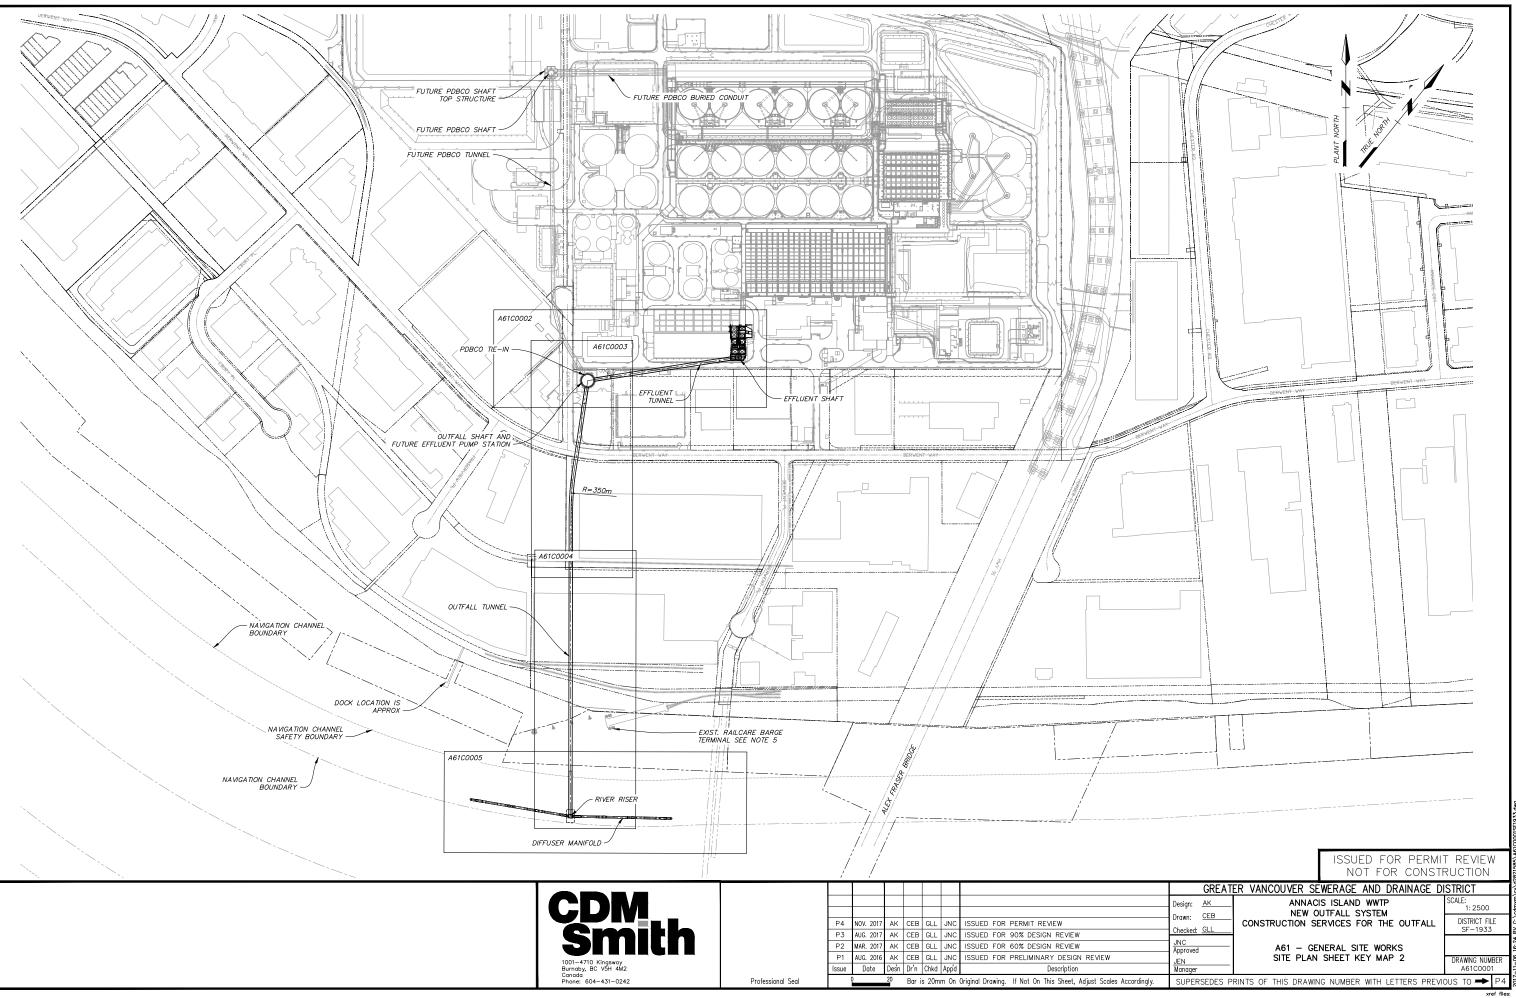

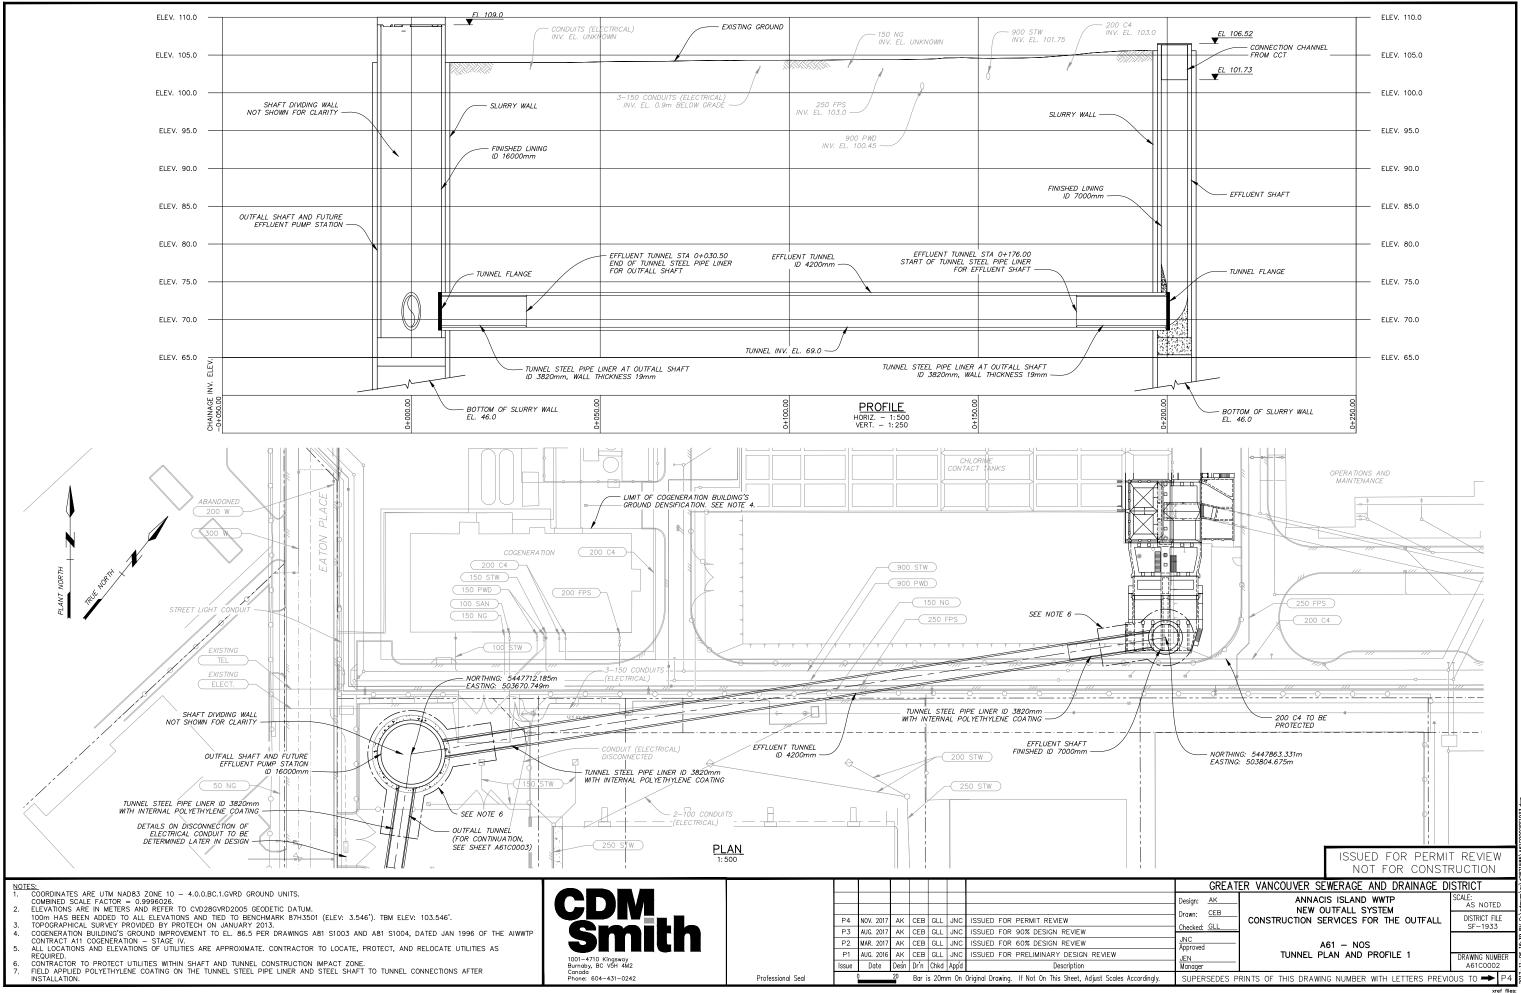


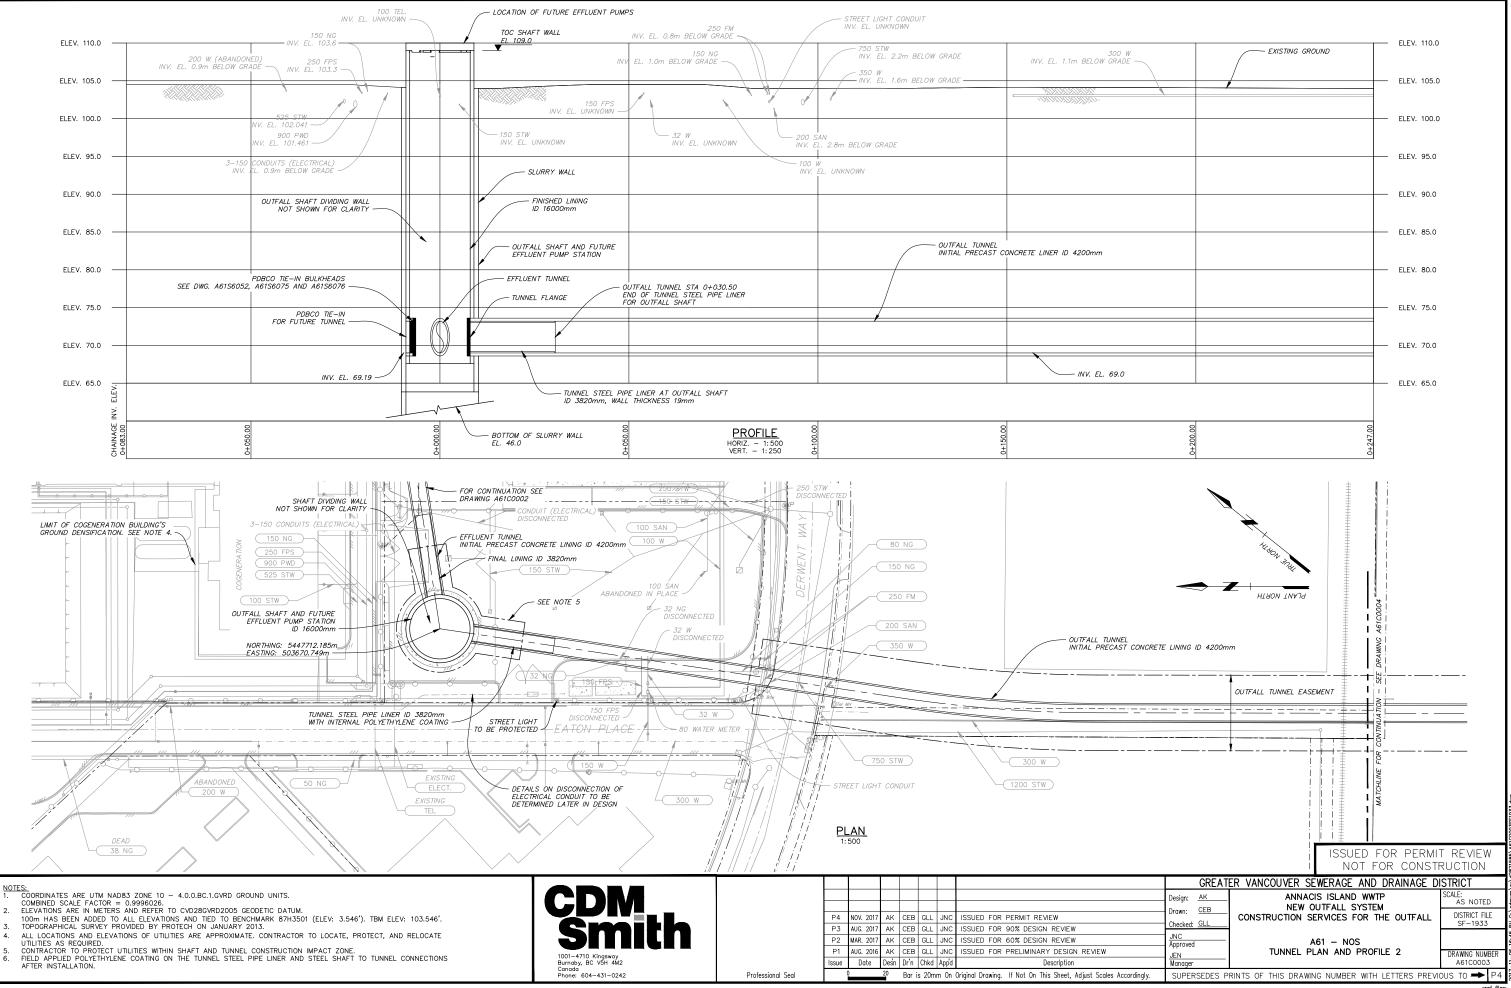



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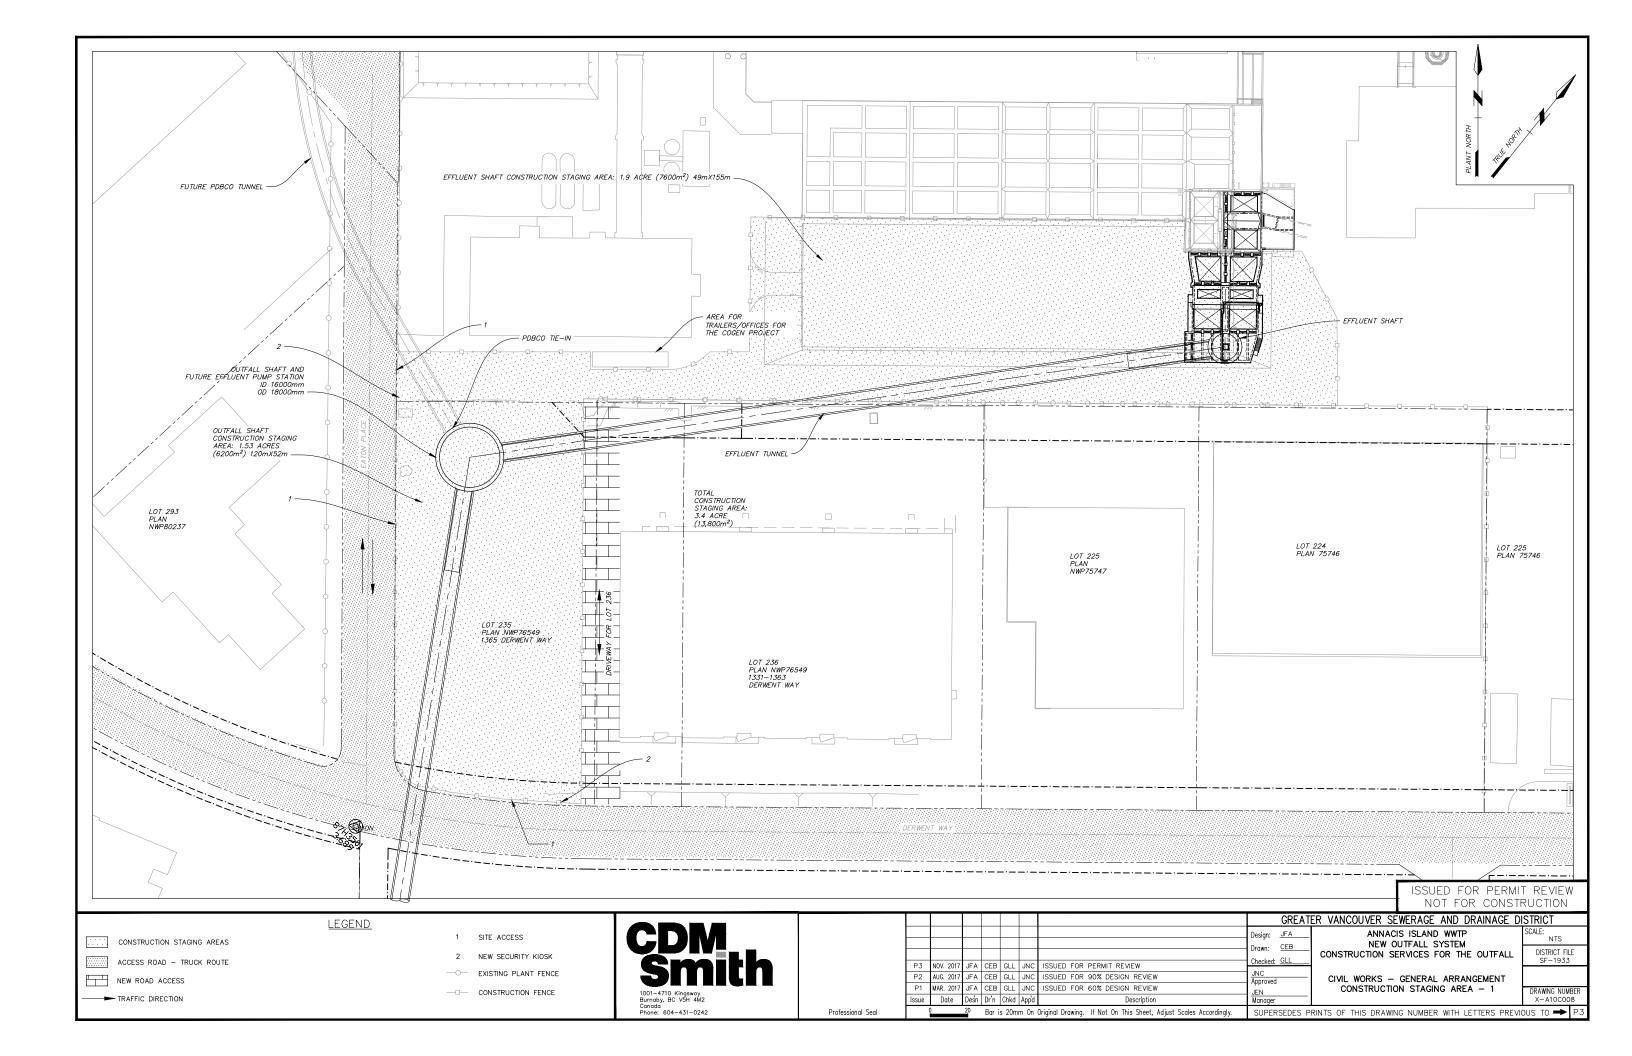



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Р3	AUG. 2017	AK	CEB	GLL	JNC	ISSUED FOR 90% DESIGN REVIEW
P2	MAR. 2017	AK	CEB	GLL	JNC	ISSUED FOR 60% DESIGN REVIEW
P1	AUG. 2016	AK	CEB	GLL	JNC	ISSUED FOR PRELIMINARY DESIGN REVIEW
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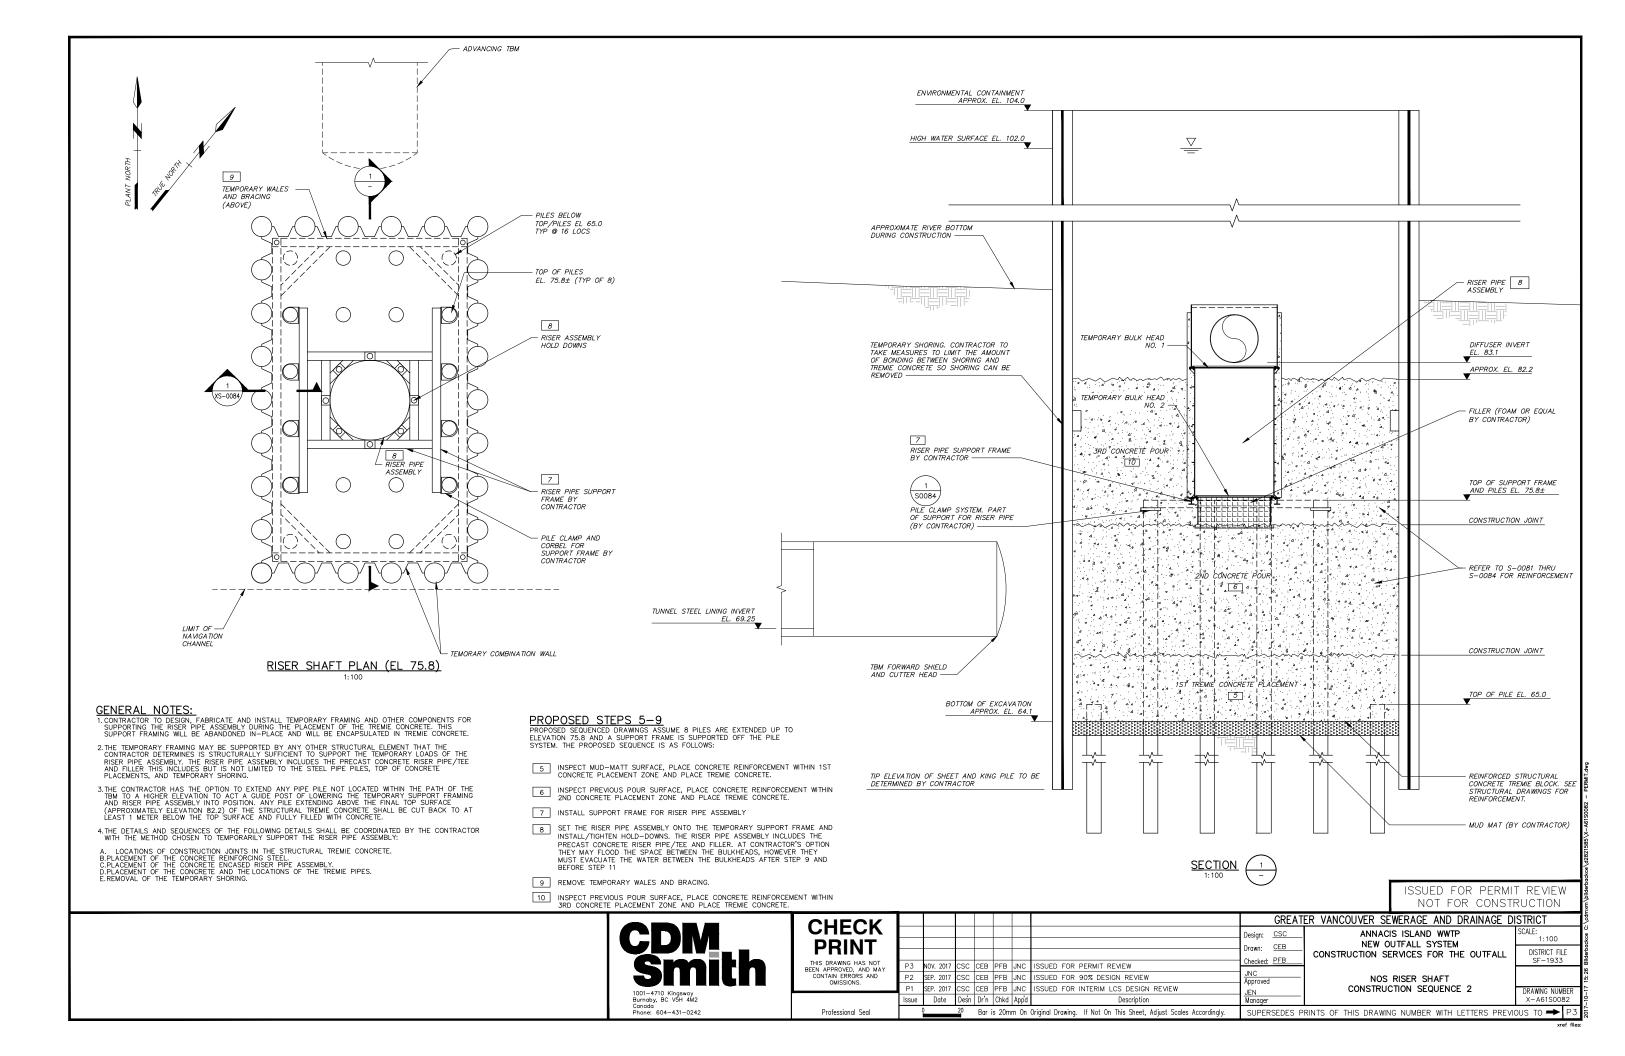





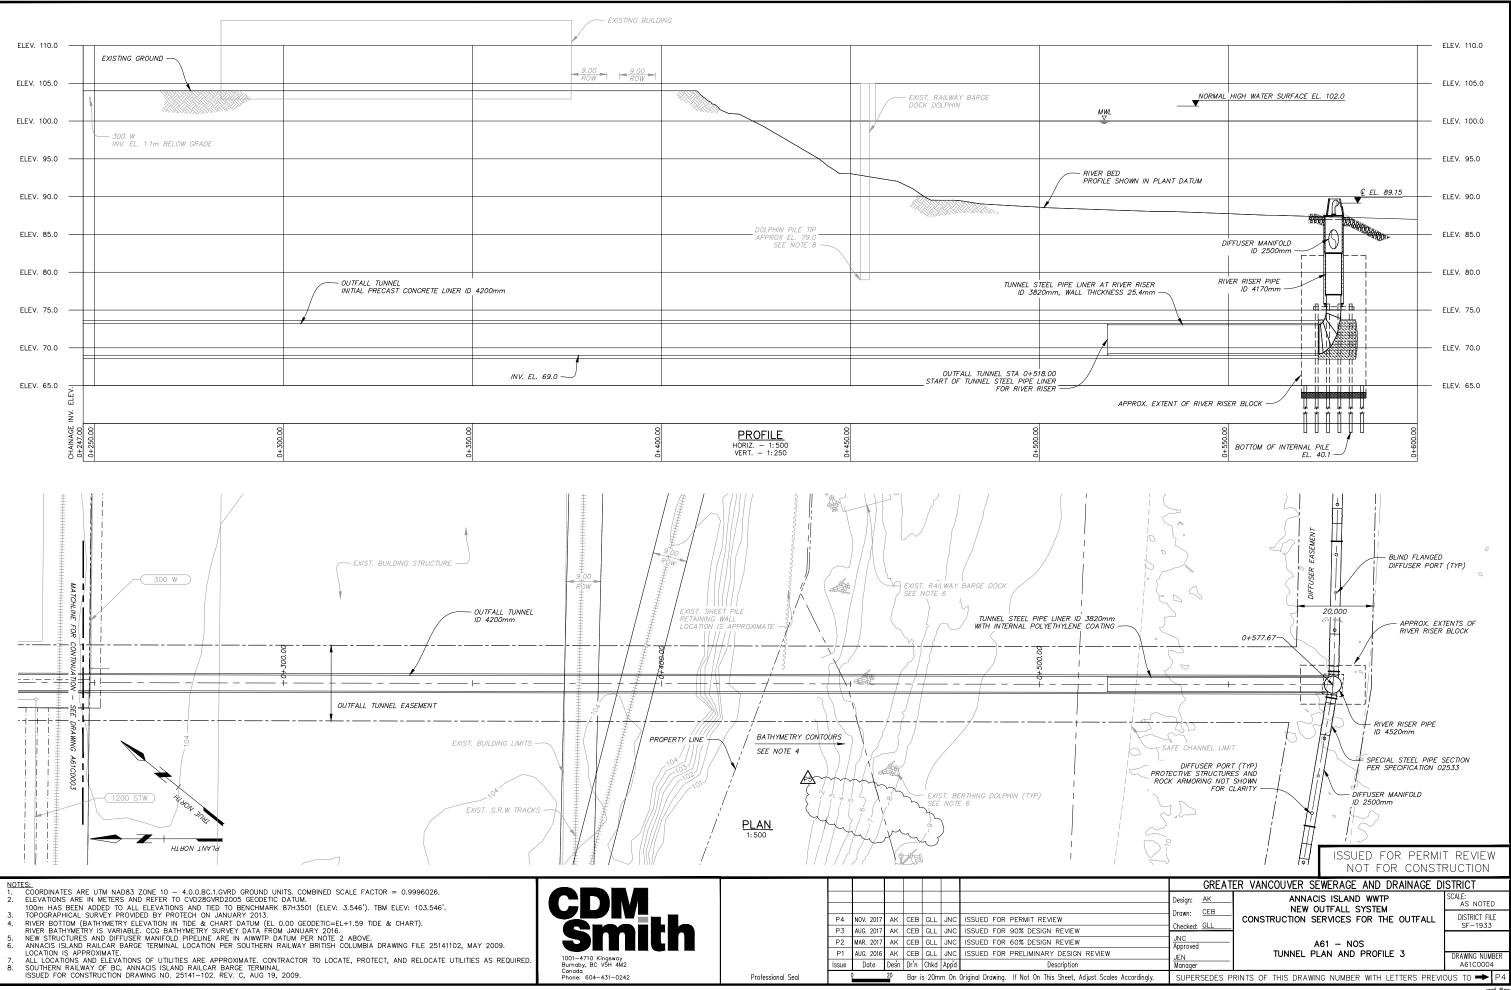


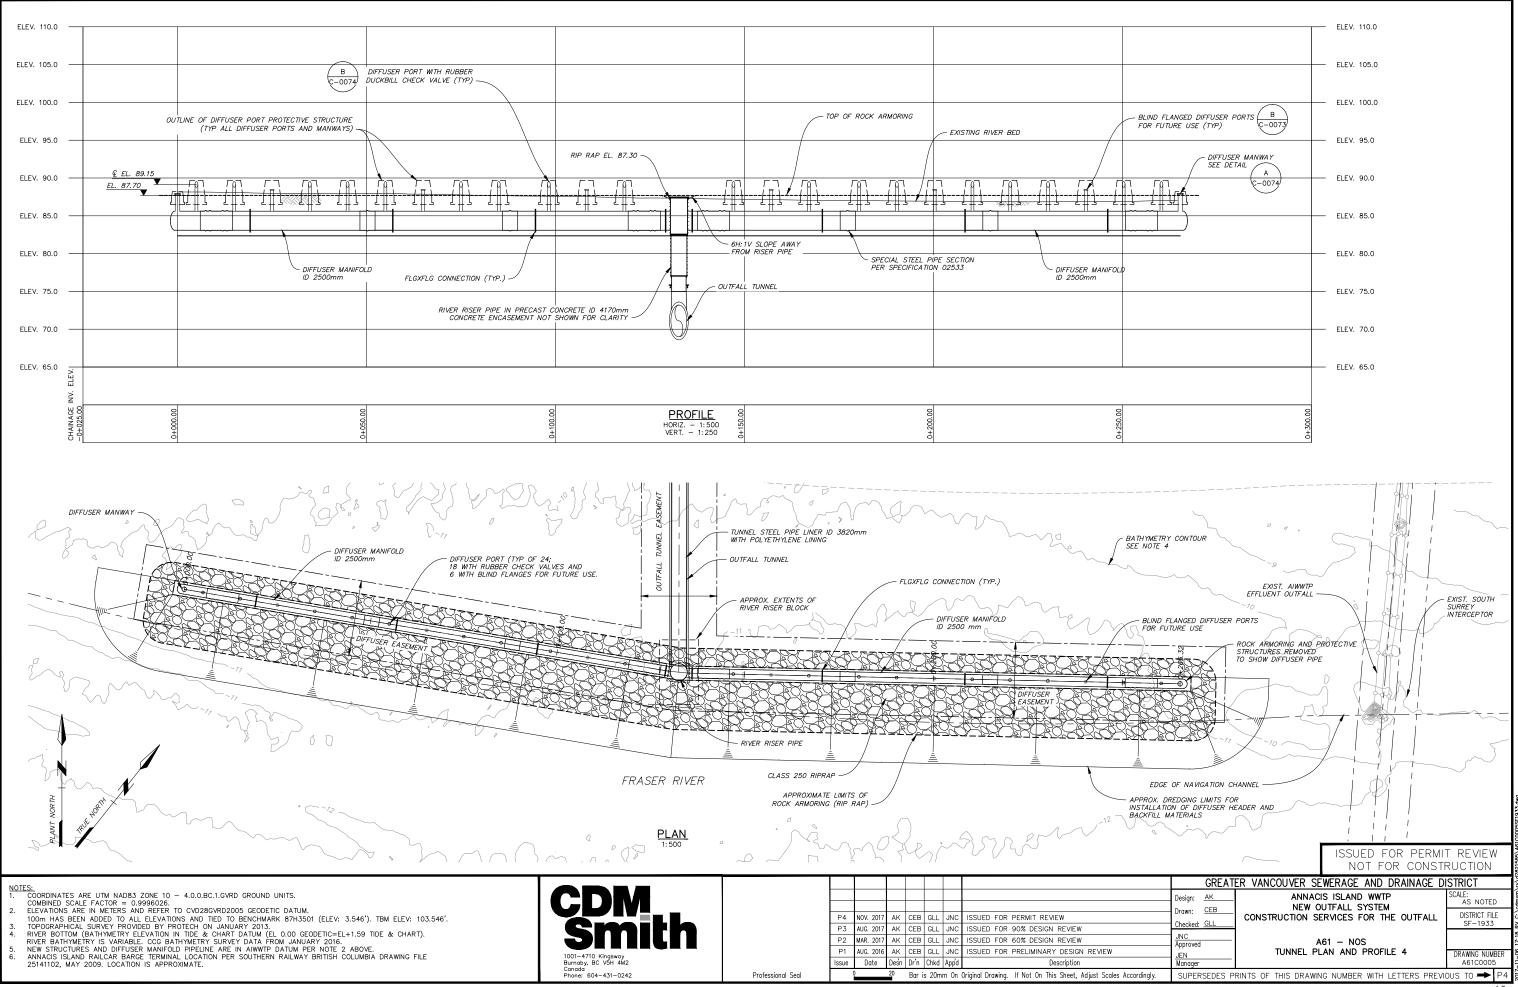


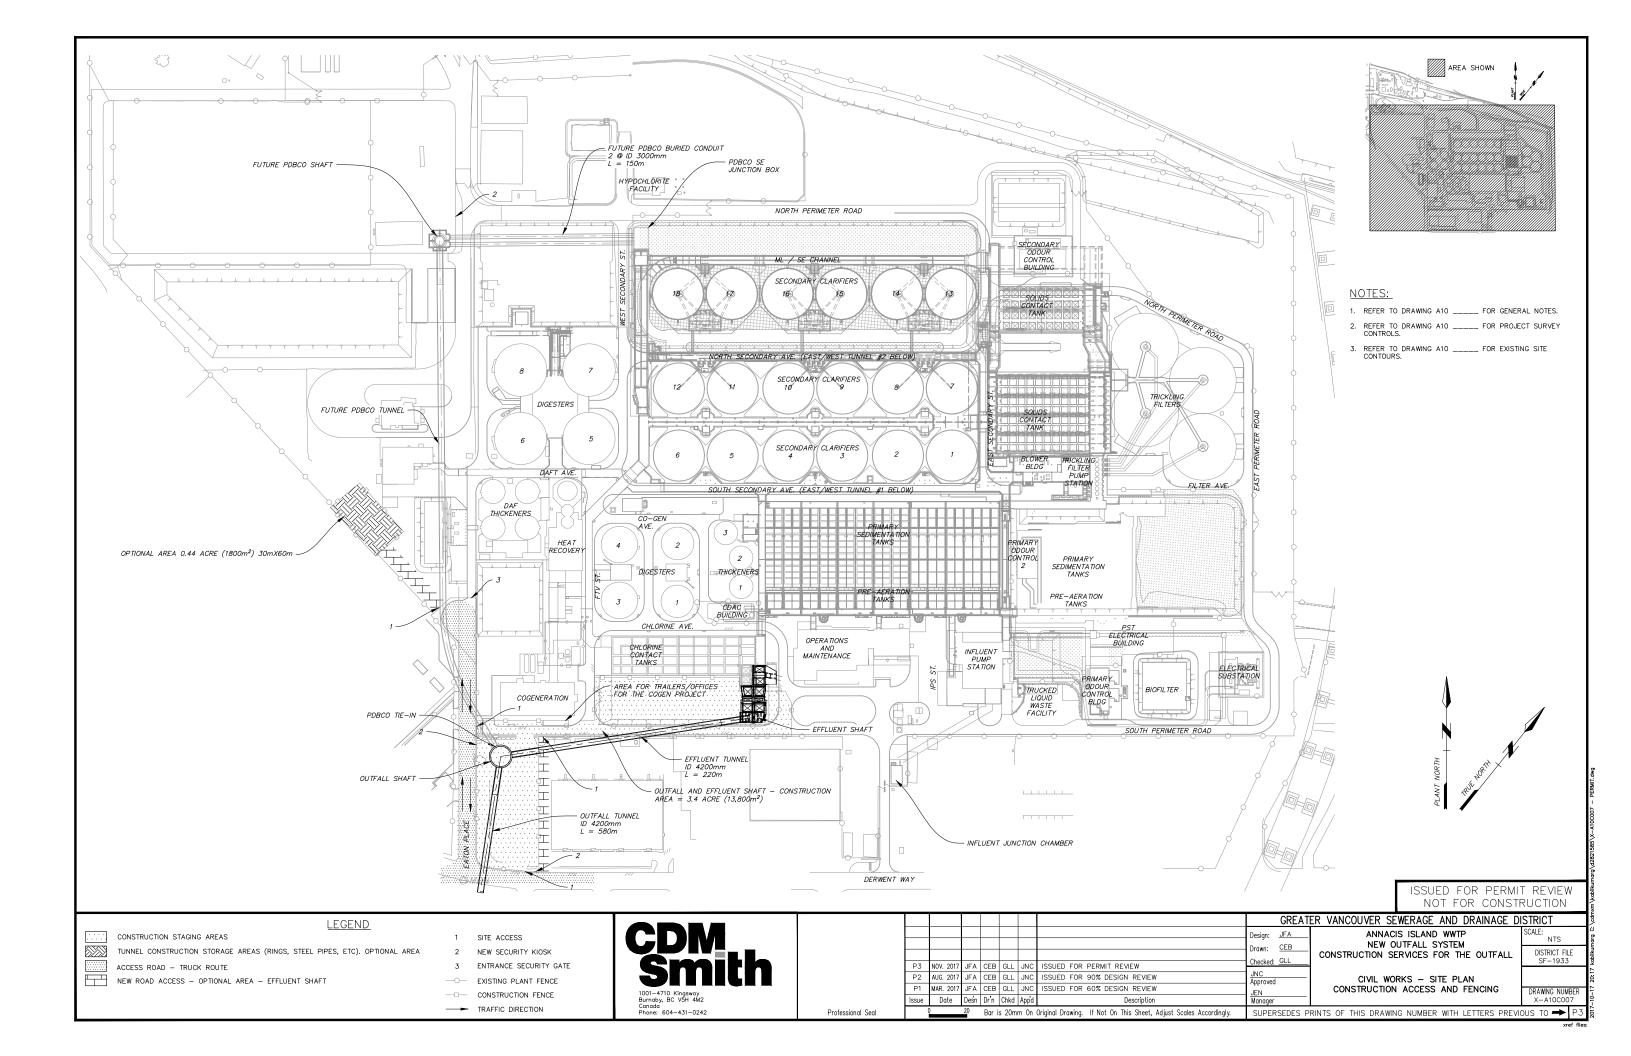

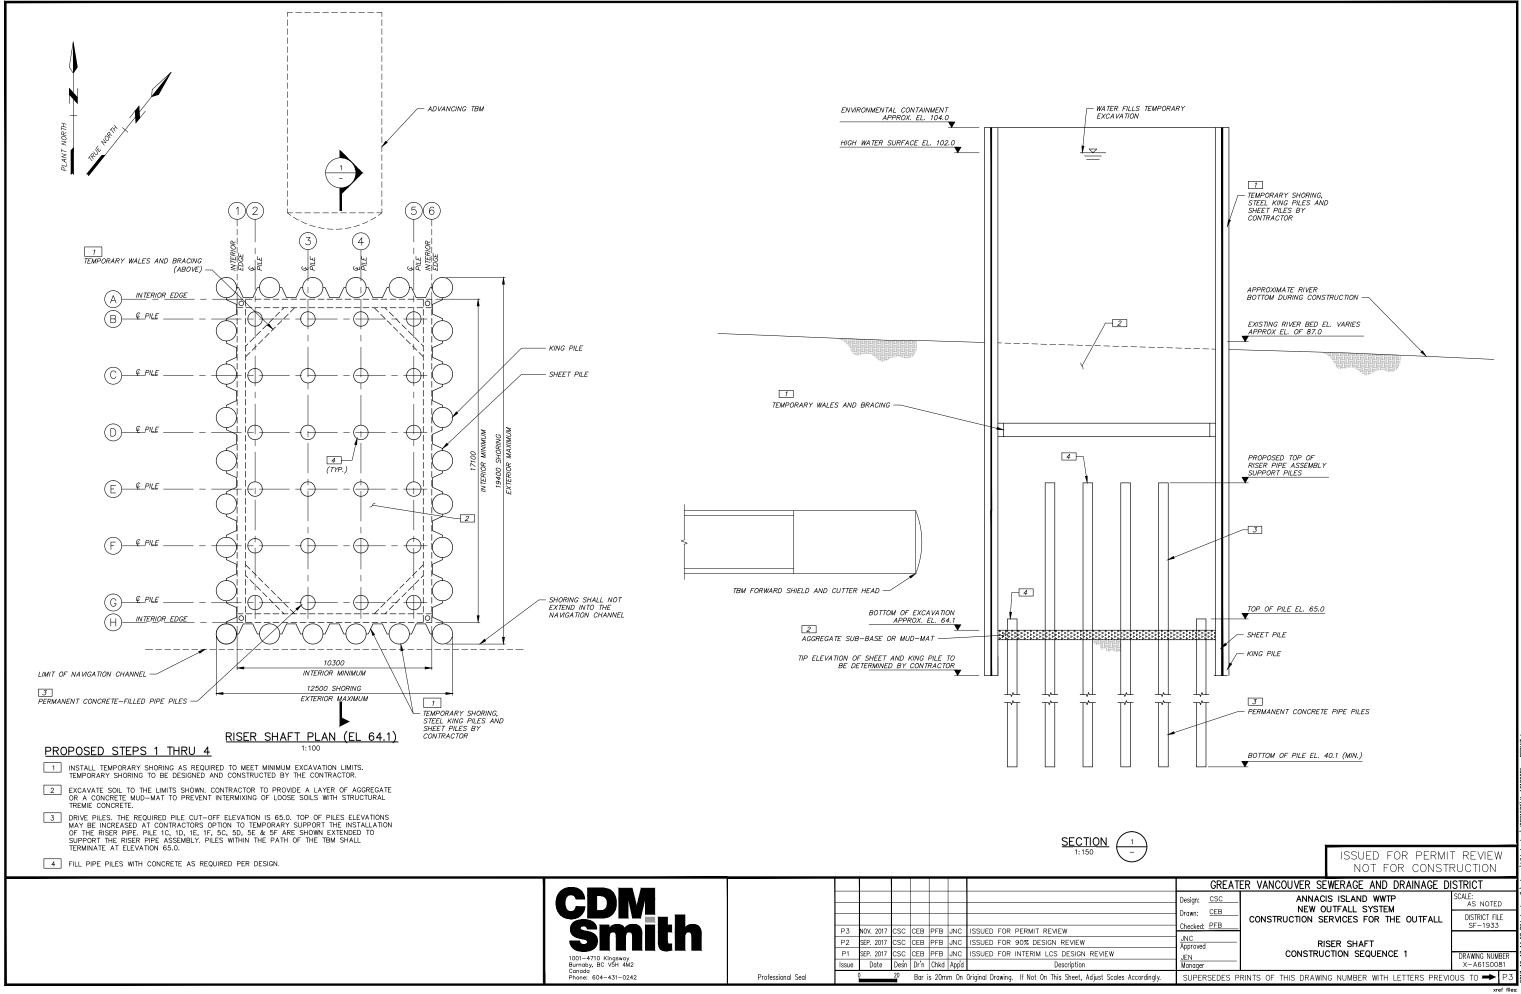

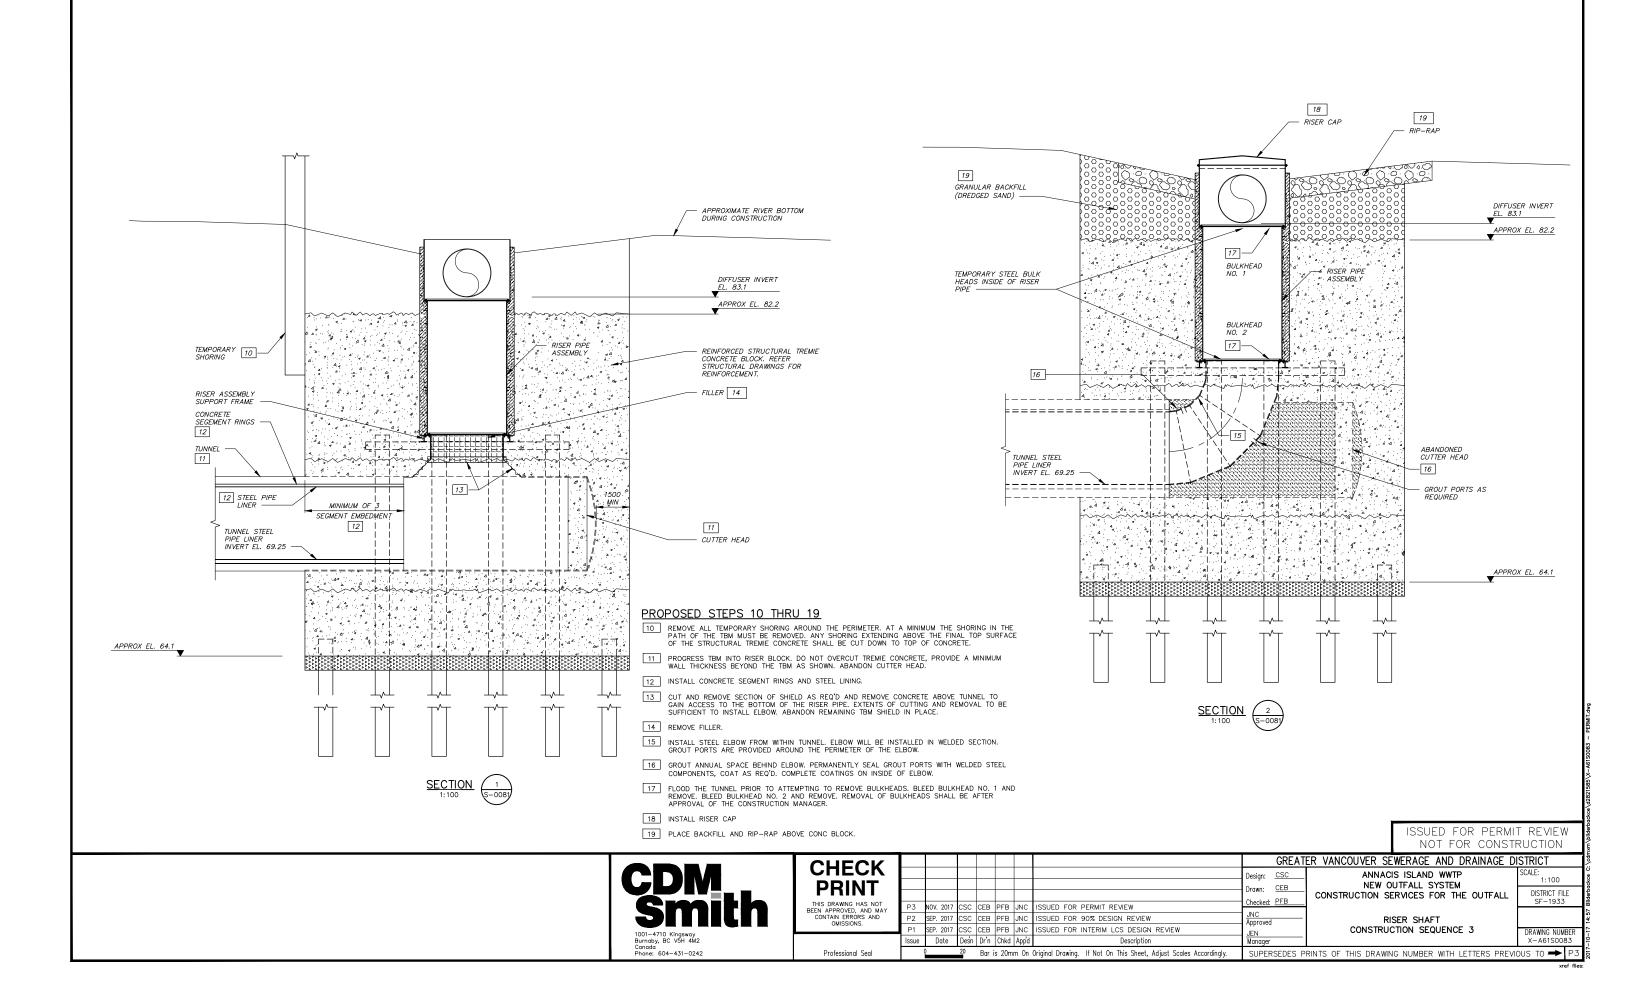

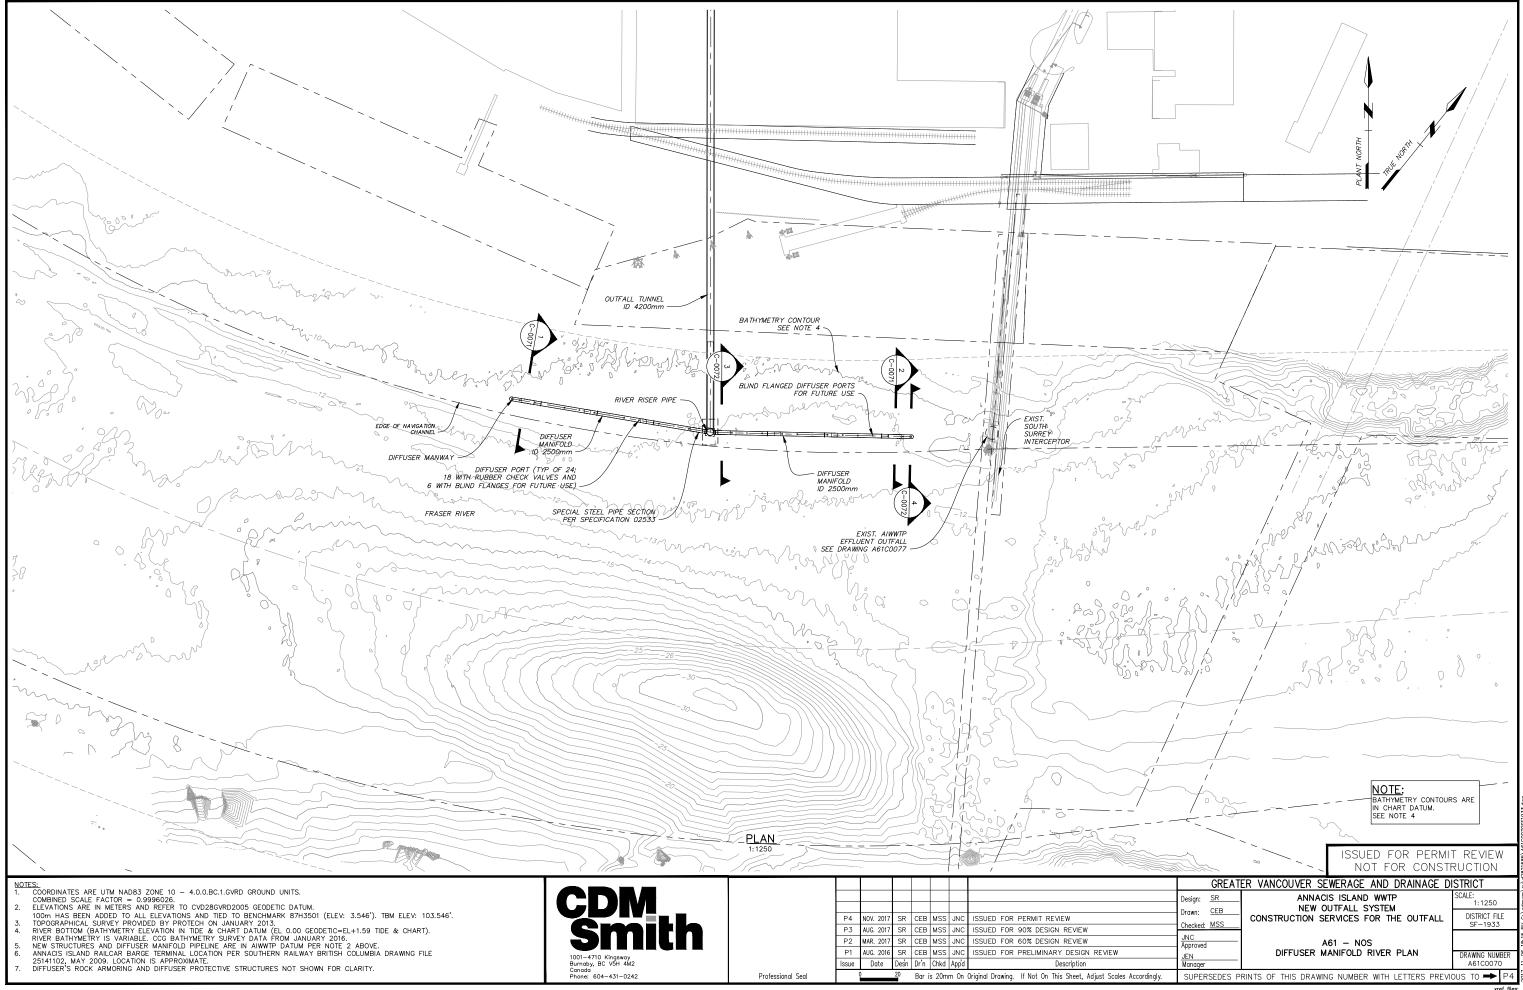

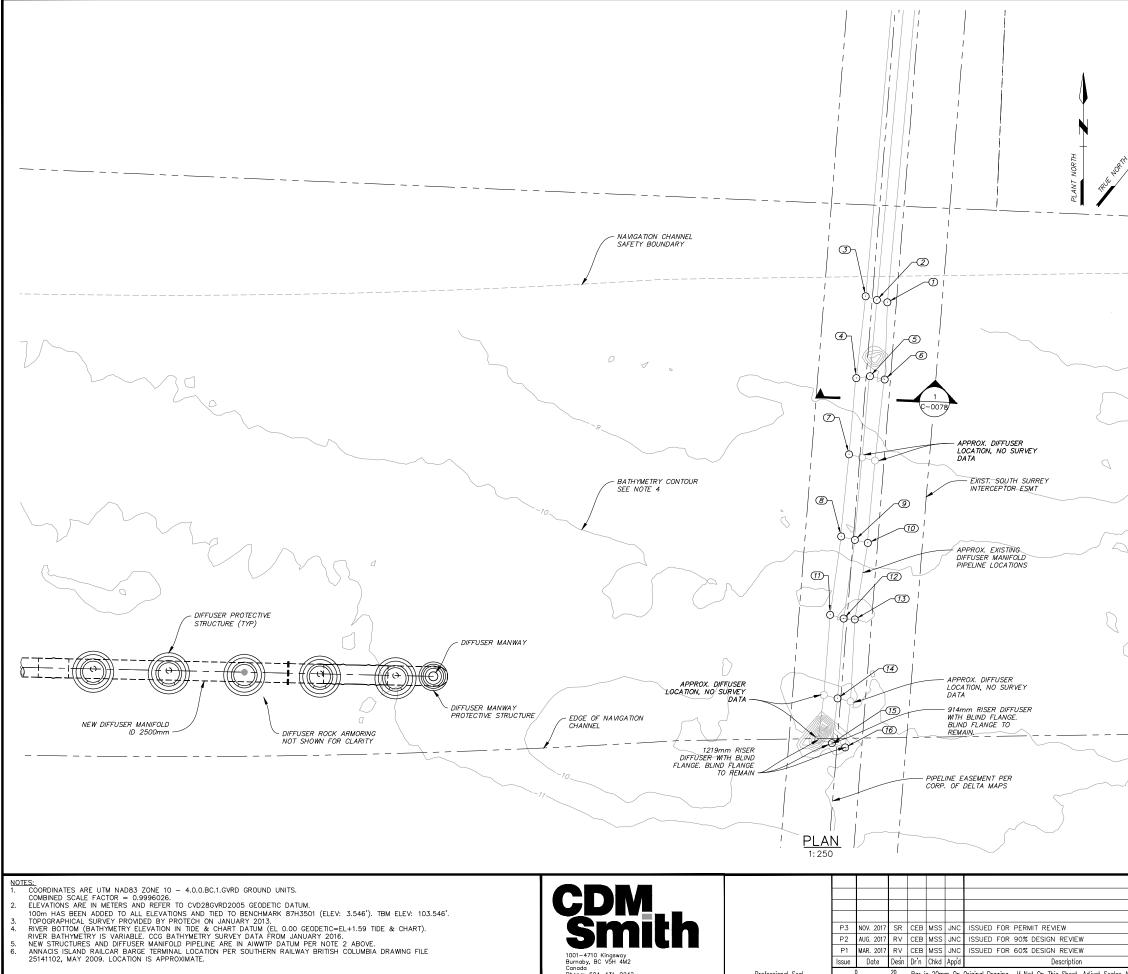



1001-4710 Kingsway Burnaby, BC V5H 4M2 Canada Phone: 604-431-0242

Professional Seal

	EXI	STING OUTF	ALL POINT	LOCATIO	ONS
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	1	5447412.9000	504139.64	DIFFUSER	RISER
	2	5447412.2500	504138.37	DIFFUSER	
1	3	5447411.6800 5447402.5600	504136.92 504142.88	DIFFUSER	
	4	5447402.5600	504142.88 504144.11	DIFFUSER	
Ň	6	5447404.8200	504145.89	DIFFUSER	
\checkmark	7	5447394.1800	504148.58	DIFFUSER	
/	8	5447385.1600	504154.71	DIFFUSER	RISER
	9	5447385.9700	504156.40	DIFFUSER	
	10	5447386.7500	504157.98	DIFFUSER	
	11	5447376.2500 5447377.0200	504160.21 504161.90	DIFFUSER	
	13	5447377.8600	504163.11	DIFFUSER	
	14	5447368.3700	504168.02	DIFFUSER	
	15	5447363.3300	504171.23	DIFFUSER	RISER
	16	5447364.0200	504172.94	DIFFUSER	RISER
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	5	~^^^^	BATHYME CHART D SEE NOTI LOCATION OUTFALL	TRY CONTOUR ATUM. E 4 I OF ANNACIS DIFFUSERS A	WWTP S INTERPRETED
	5		BATHYME CHART D SEE NOTI LOCATION OUTFALL FROM 20	TRY CONTOUF ATUM. E 4 N OF ANNACIS DIFFUSERS A 16 MV MULTIE R PERMIT	" WWTP S INTERPRETED BEAM SURVEY
· ·	5		BATHYME CHART D SEE NOT LOCATION OUTFALL FROM 20 SSUED FOR NOT FOR	TRY CONTOUF ATUM. E 4 N OF ANNACIS DIFFUSERS A 16 MV MULTIE R PERMIT CONSTF	WWTP S INTERPRETED BEAM SURVEY REVIEW
		COUVER SEWER	BATHYME CHART D SEE NOT LOCATION OUTFALL FROM 20 SSUED FOR NOT FOR AGE AND DR	TRY CONTOUF ATUM. E 4 OF ANNACIS DIFFUSERS A 16 MV MULTIE R PERMIT CONSTF	REVIEW SUCTION
Design: <u>F</u>	₹٧	COUVER SEWERA	BATHYME CHART D SEE NOT LOCATION OUTFALL FROM 20 SUED FOR NOT FOR AGE AND DR AND WWTP	TRY CONTOUF ATUM. E 4 OF ANNACIS DIFFUSERS A 16 MV MULTIE R PERMIT CONSTF	REVIEW
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Design: <u>F</u> Drawn: <u>C</u> Checked: <u>N</u> <u>JNC</u> Approved		COUVER SEWER/ ANNACIS ISI NEW OUTFA RUCTION SERVIC A61 -	BATHYME CHART D SEE NOTI LOCATION OUTFALL FROM 20 SSUED FOR NOT FOR AGE AND DR AGE AND WYTP LL SYSTEM ES FOR THE NOS	TRY CONTOUP ATUM. E 4 J OF ANNACIS DIFFUSERS A 16 MV MULTIE R PERMIT CONSTE AINAGE DI	REVIEW RUCTION SCALE: 1:250 DISTRICT FILE SF-1933
Design: <u>F</u> Drawn: <u>Checked: M</u> JNC		COUVER SEWER/ ANNACIS ISL NEW OUTFA RUCTION SERVIC	BATHYME CHART D SEE NOTI LOCATION OUTFALL FROM 20 SSUED FOR NOT FOR AGE AND DR AGE AND WYTP LL SYSTEM ES FOR THE NOS	TRY CONTOUP ATUM. E 4 J OF ANNACIS DIFFUSERS A 16 MV MULTIE R PERMIT CONSTE AINAGE DI	REVIEW SCALE: 1:250 DISTRICT FILE


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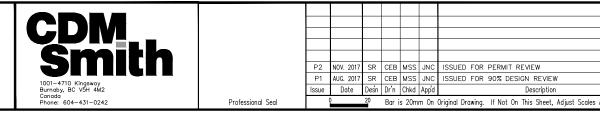
		O.D. OF I.D. OF		DRILLING			
PIPE SIZE mm	FLANGE FLANGE OF FLANGE	DIA. OF BOLTCIRCLE	BOI	_TS			
				B-mm	NO.	DIA.	
450	635	462	39.4	577.4	6	29	
610	813	614	47.1	749.0	8	32	
914	1168	919	60.1	1085.4	12	38	
1219	1511	1224	69.4	1422.4	16	38	

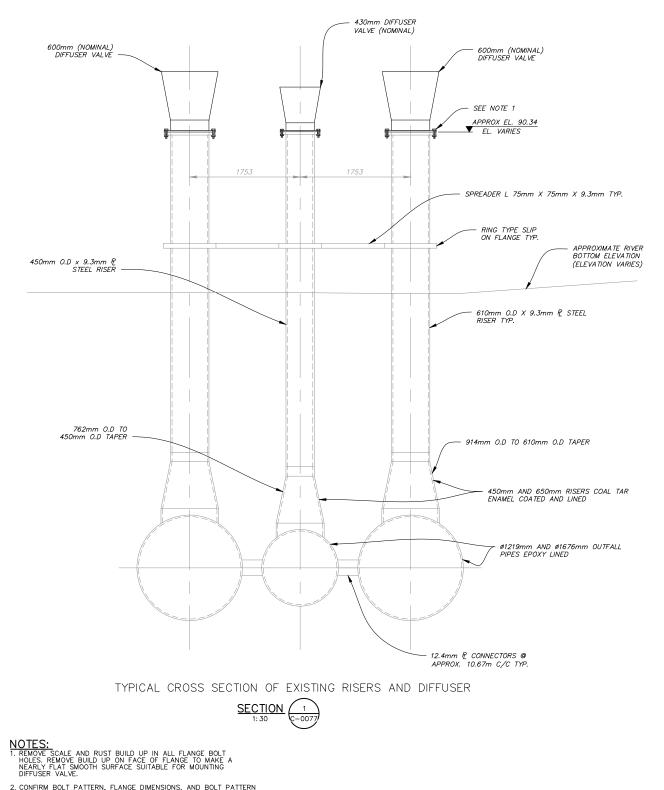STEEL RING FLANGE DIMENSION TABLE

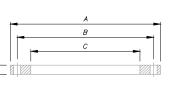


DETAIL 1: 30

- 2. CONFIRM BOLT PATTERN, FLANGE DIMENSIONS, AND BOLT PATTERN ORIENTATION. COORDINATE WITH DIFFUSER VALVE MANUFACTURER TO ENSURE VALVE IS ORIENTATED IN THE DIRECTION AS NOTED.
- 3. USE SS 316 HARDWARE FOR MOUNTING.

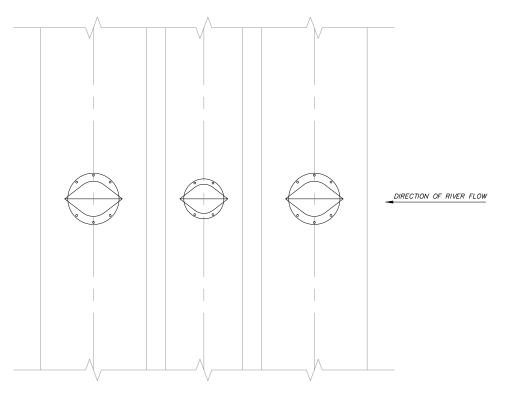


TYPICAL DIFFUSER VALVE PLAN VIEW DETAIL


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	GREAT	ER VANCOUVER SE	WERAGE AND DRA	AINAGE DI	STRICT	2
	Design: <u>SR</u> Drawn: <u>CEB</u> Checked: <u>MSS</u> JNC	NEW O CONSTRUCTION SE	S ISLAND WWTP UTFALL SYSTEM RVICES FOR THE (SCALE: 1: 30 DISTRICT FILE SF-1933	18:57 RV C: \cdmxm'
Accordingly	Approved JEN Manager	RINTS OF THIS DRAWN			DRAWING NUMB A61C0078	98-11-2
Accordingly.	SUPERSEDES P	KINTS OF THIS DRAWIN	G NUMBER WITH LETT	EKS PREVIC		PZ 8

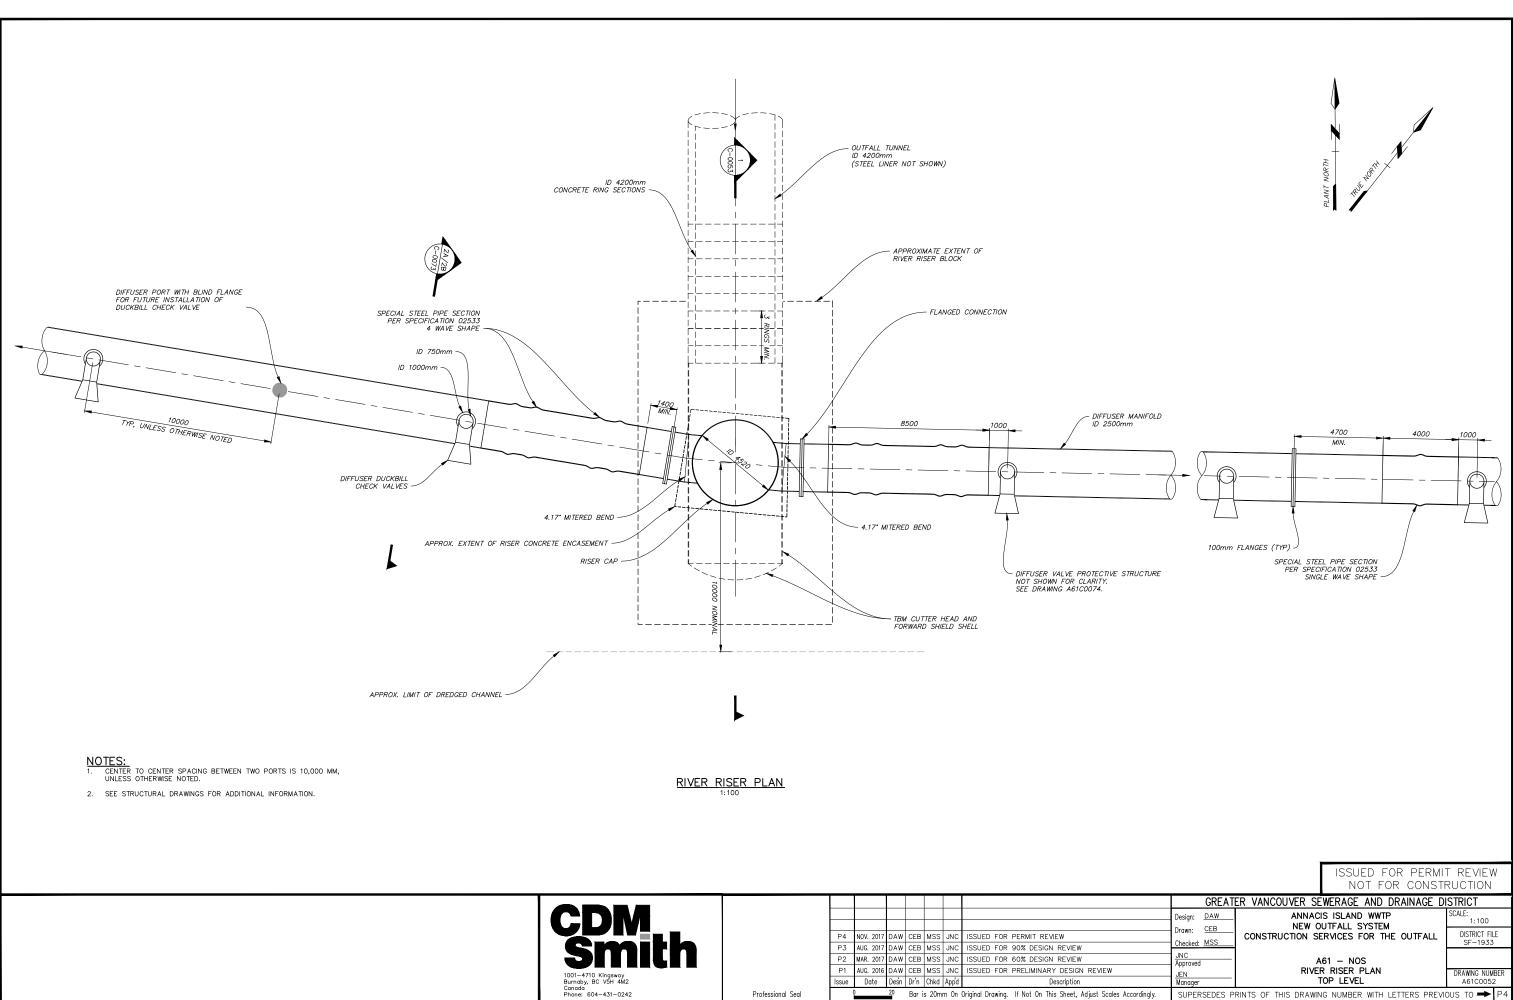


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	Checked: MSS		SF-1933	Γ
	JNC Approved	A61 – NOS		17:2(
	JEN Manager	RIVER RISER PLAN TOP LEVEL	DRAWING NUMBER A61C0052	-11-06
Accordingly.	SUPERSEDES P	RINTS OF THIS DRAWING NUMBER WITH LETTERS PREVI	OUS TO <table-cell-rows> P4</table-cell-rows>	2017
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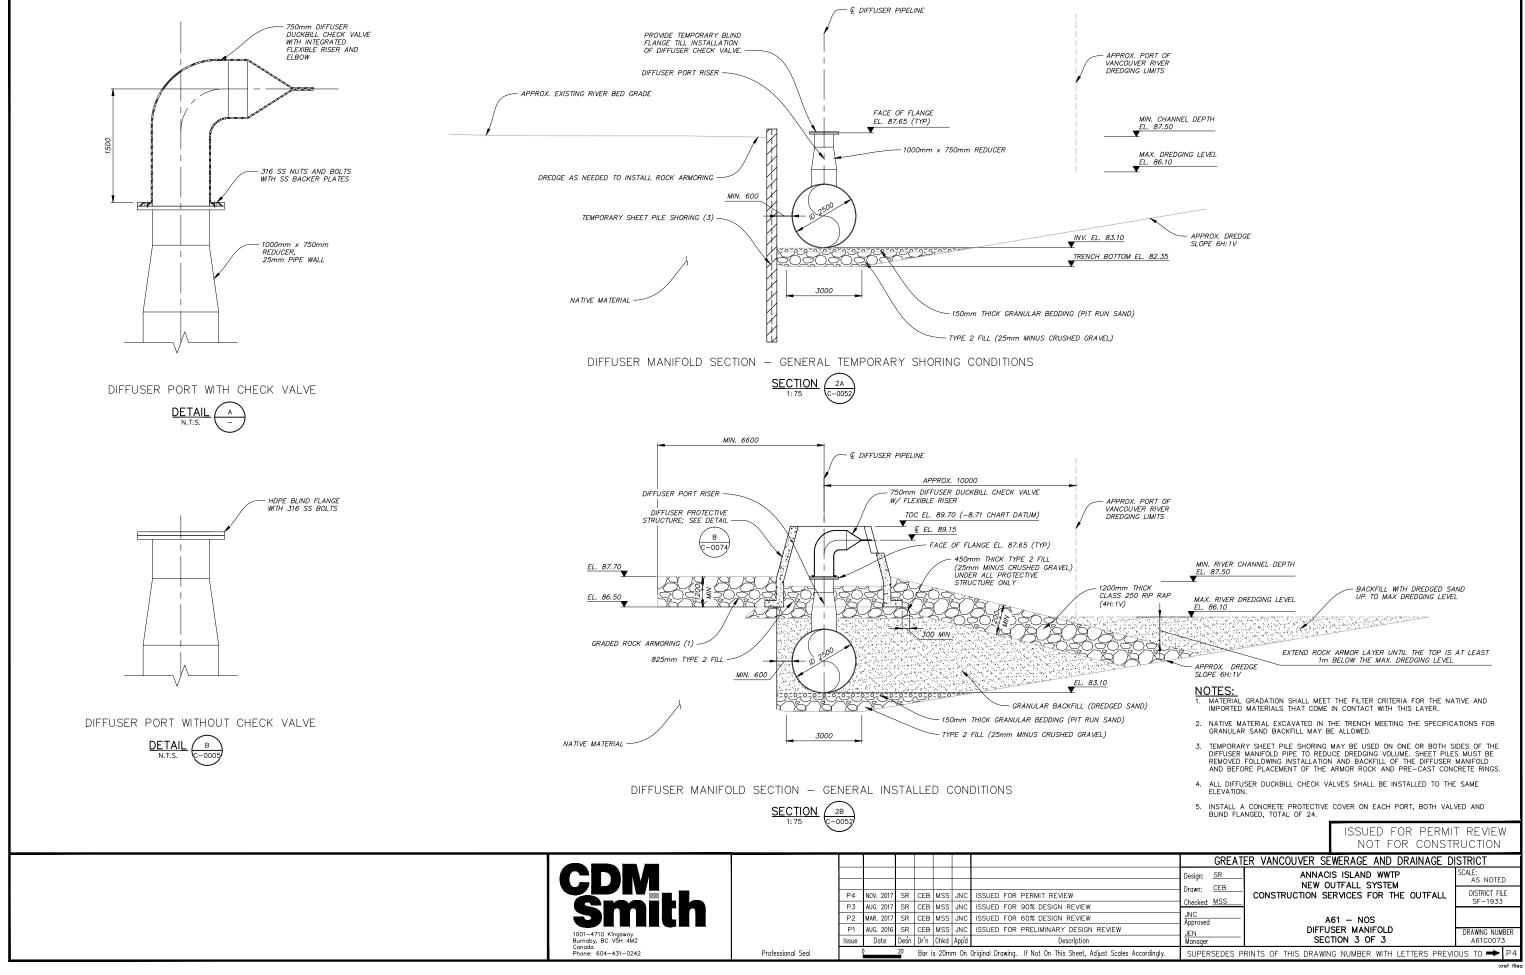
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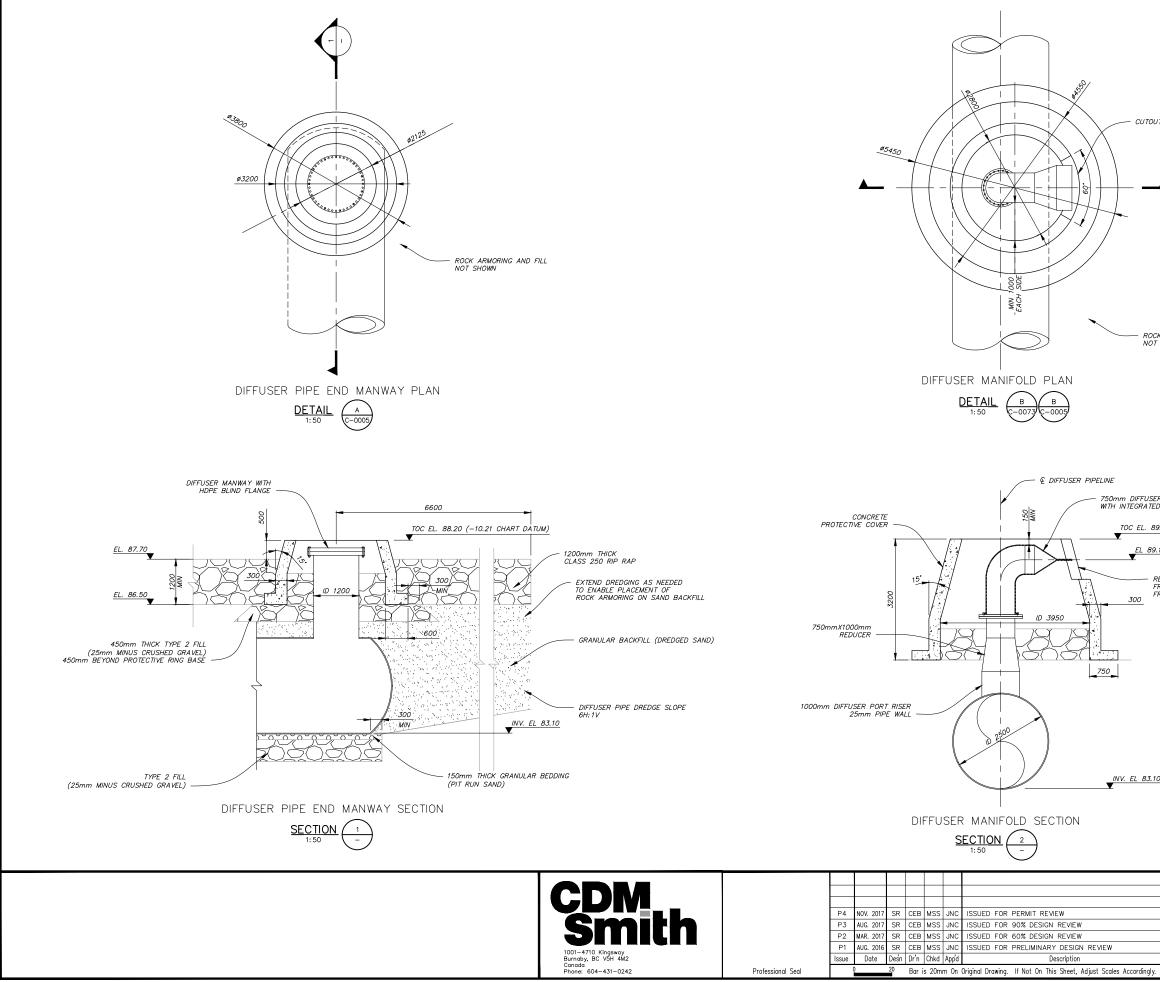


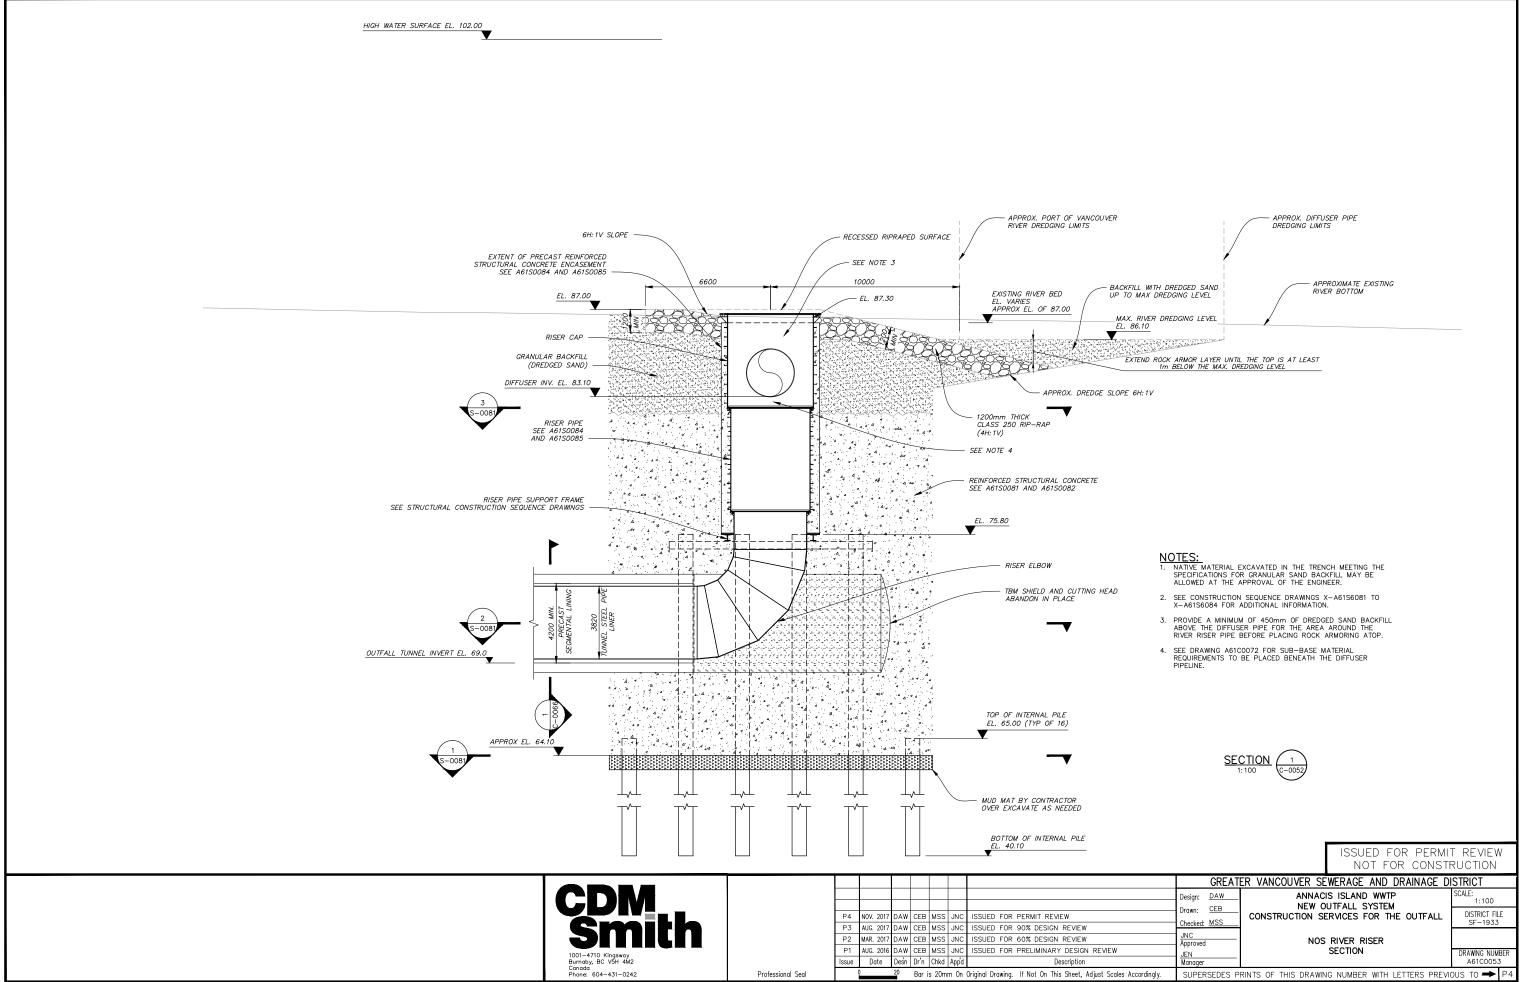1-06 18:29 RV C: \cdmxm\rv\d2821585\A6

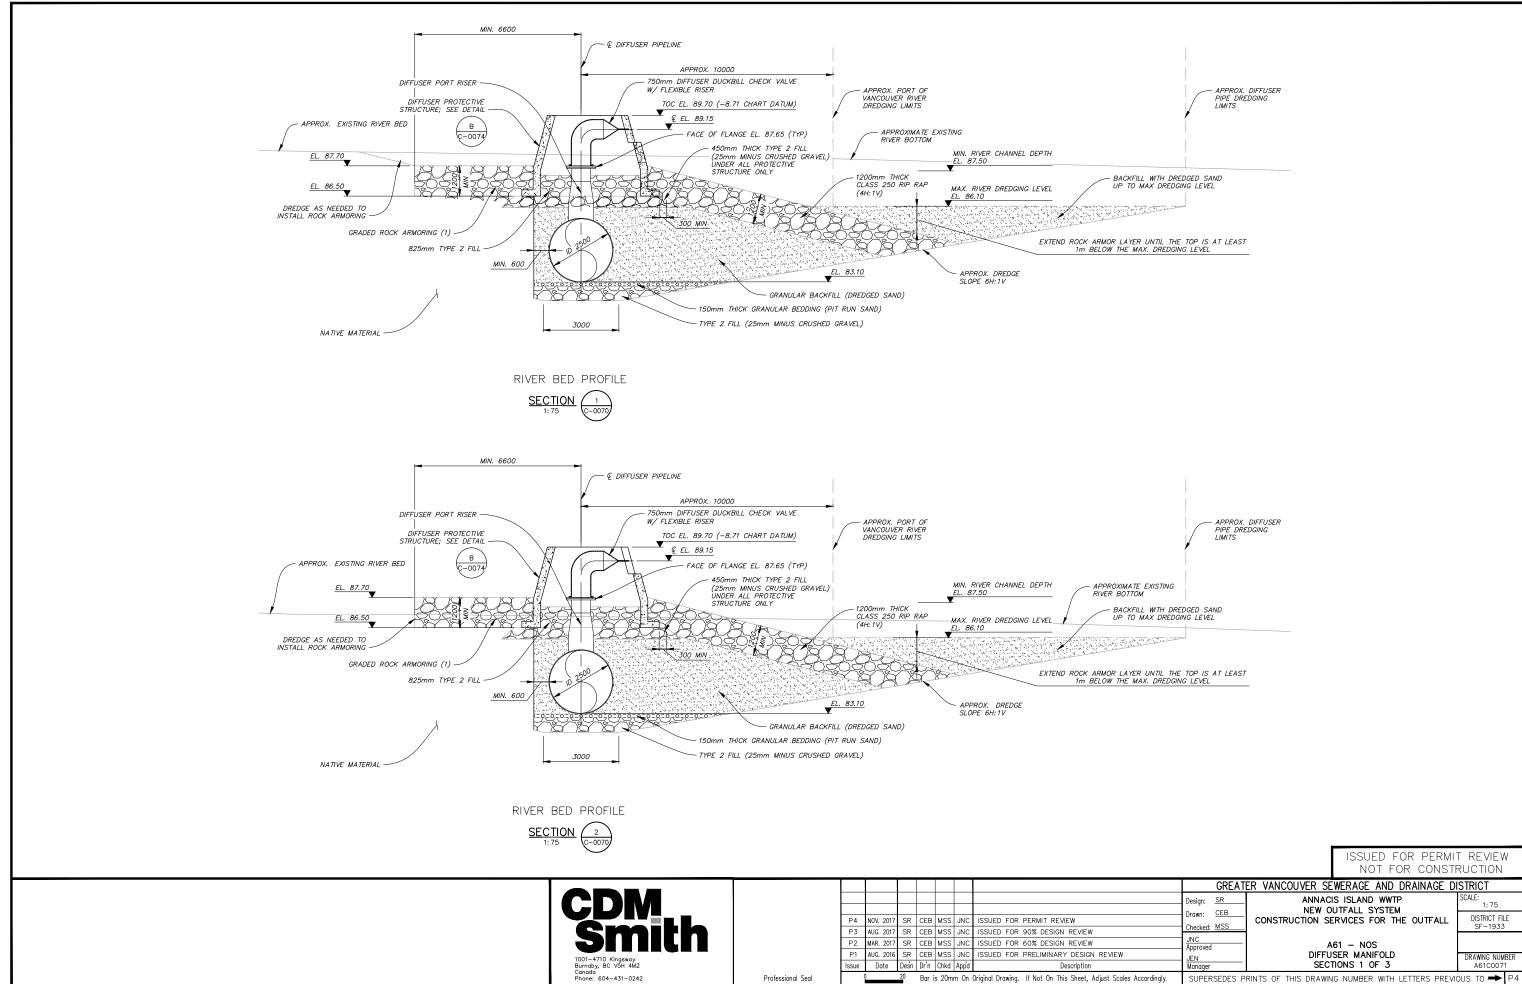

D6 18: 30 RV C: \cdmxm\rv\d2821585\A61C0072S




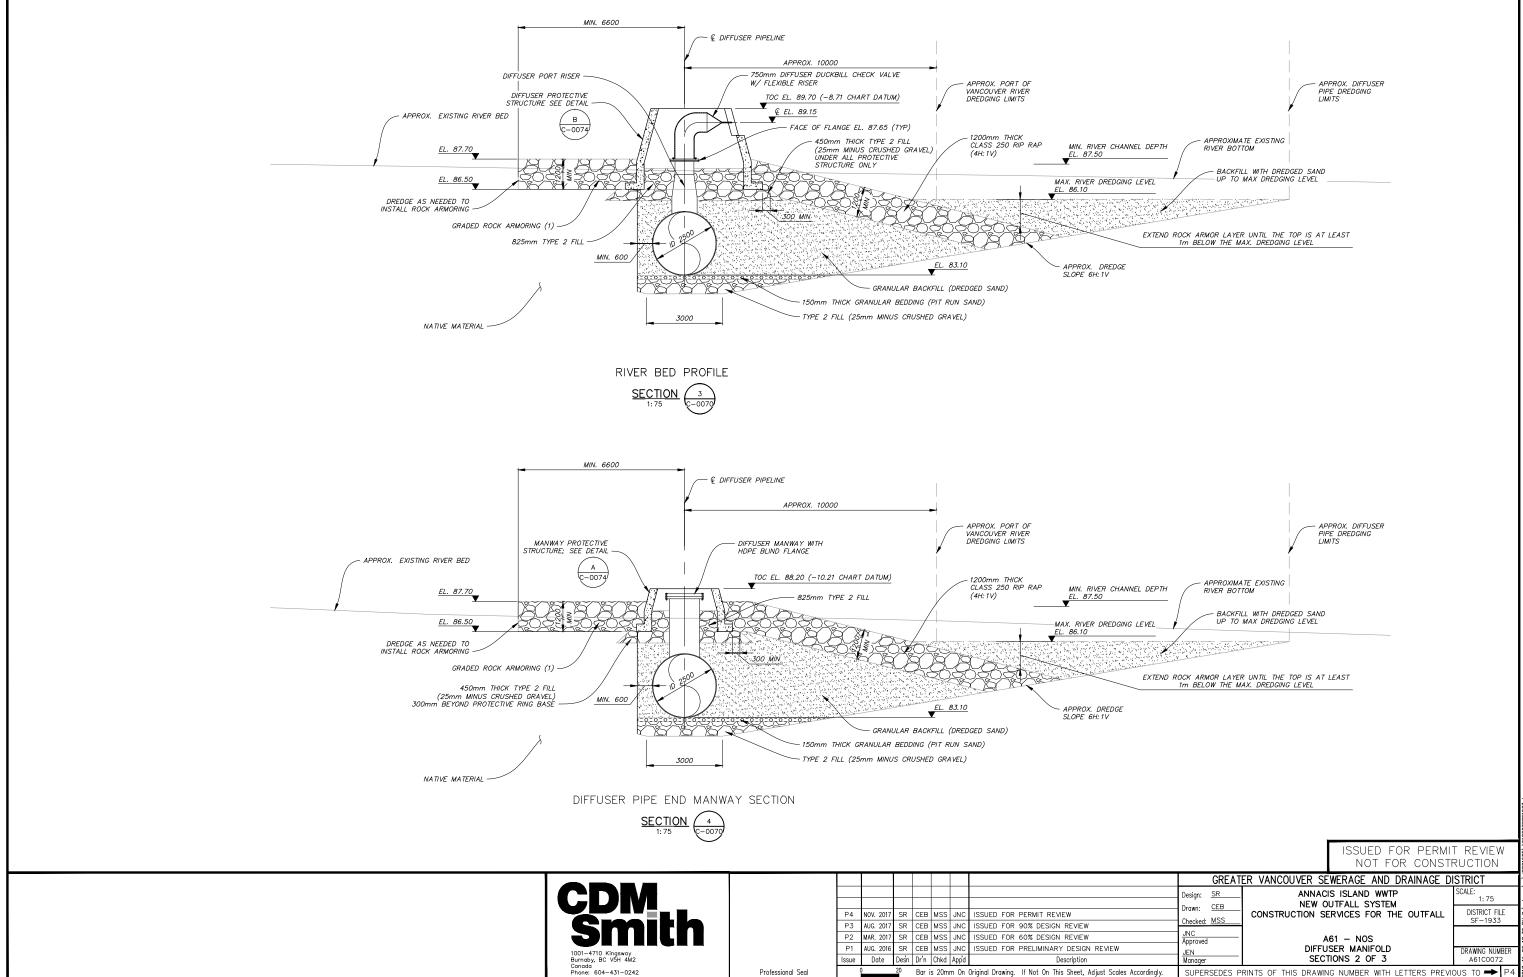


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	Design: <u>SR</u> Drawn: <u>CEB</u>		NEW OUT	ISLAND WW	EM	1:50 DISTRICT FILE
	Checked: MSS	CONSTRUC	IION SER	ICES FOR	THE OUTFALL	SF-1933

Approved DRAWING NUMBER A61C0074 JEN Managei SUPERSEDES PRINTS OF THIS DRAWING NUMBER WITH LETTERS PREVIOUS TO -

DIFFUSER MANIFOLD DETAILS 1

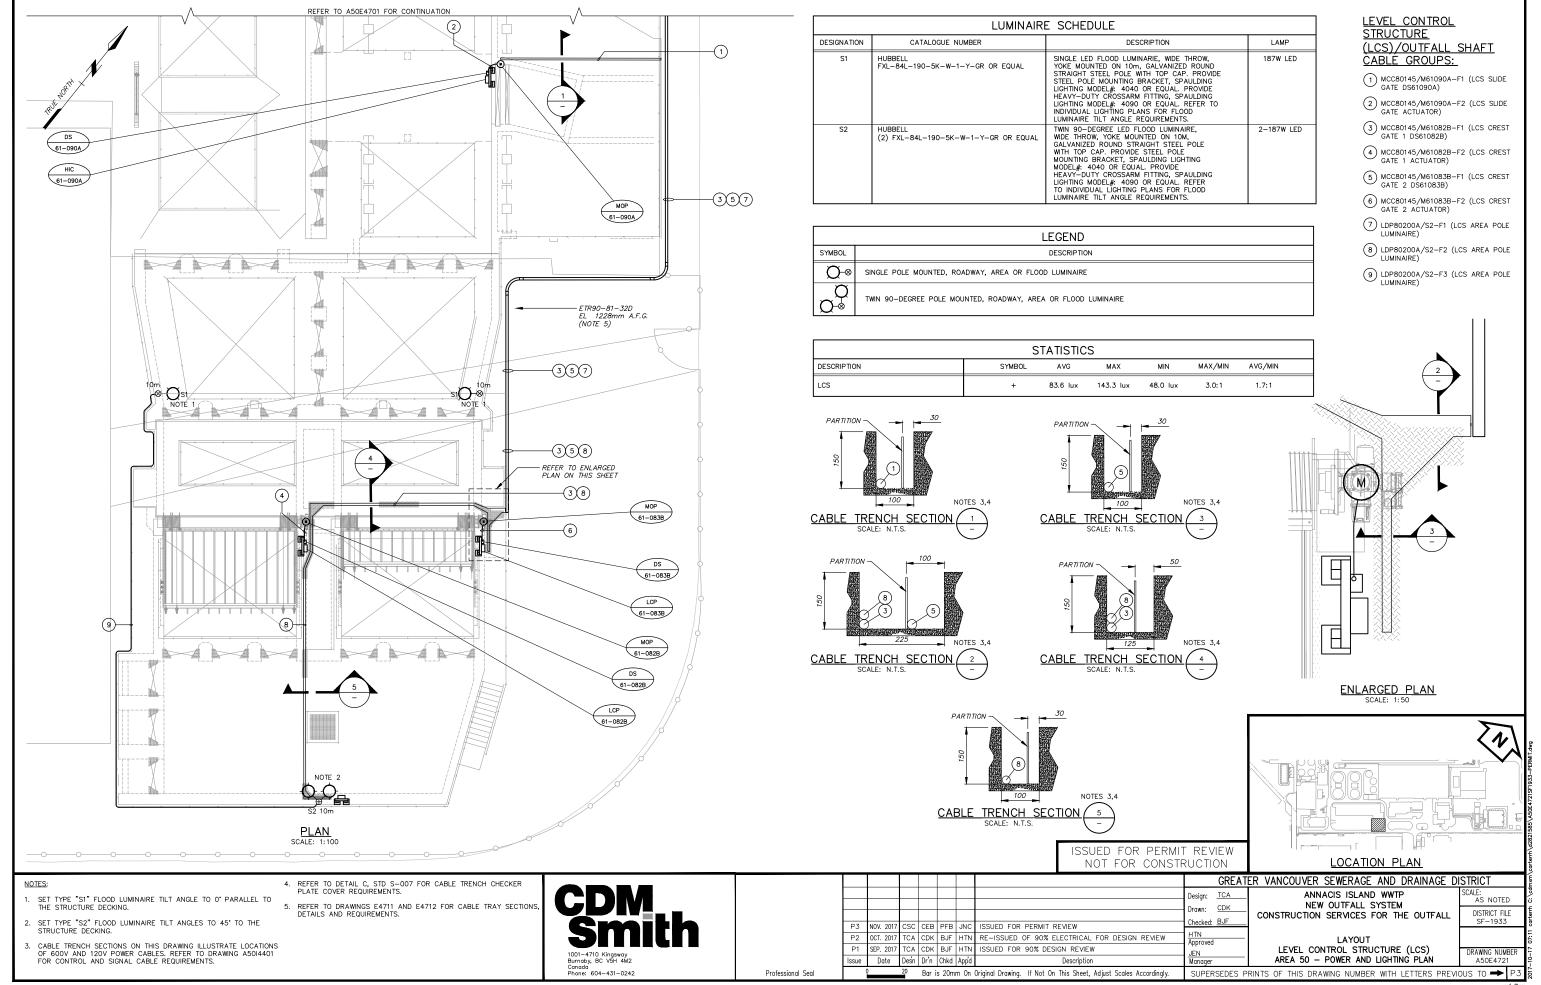

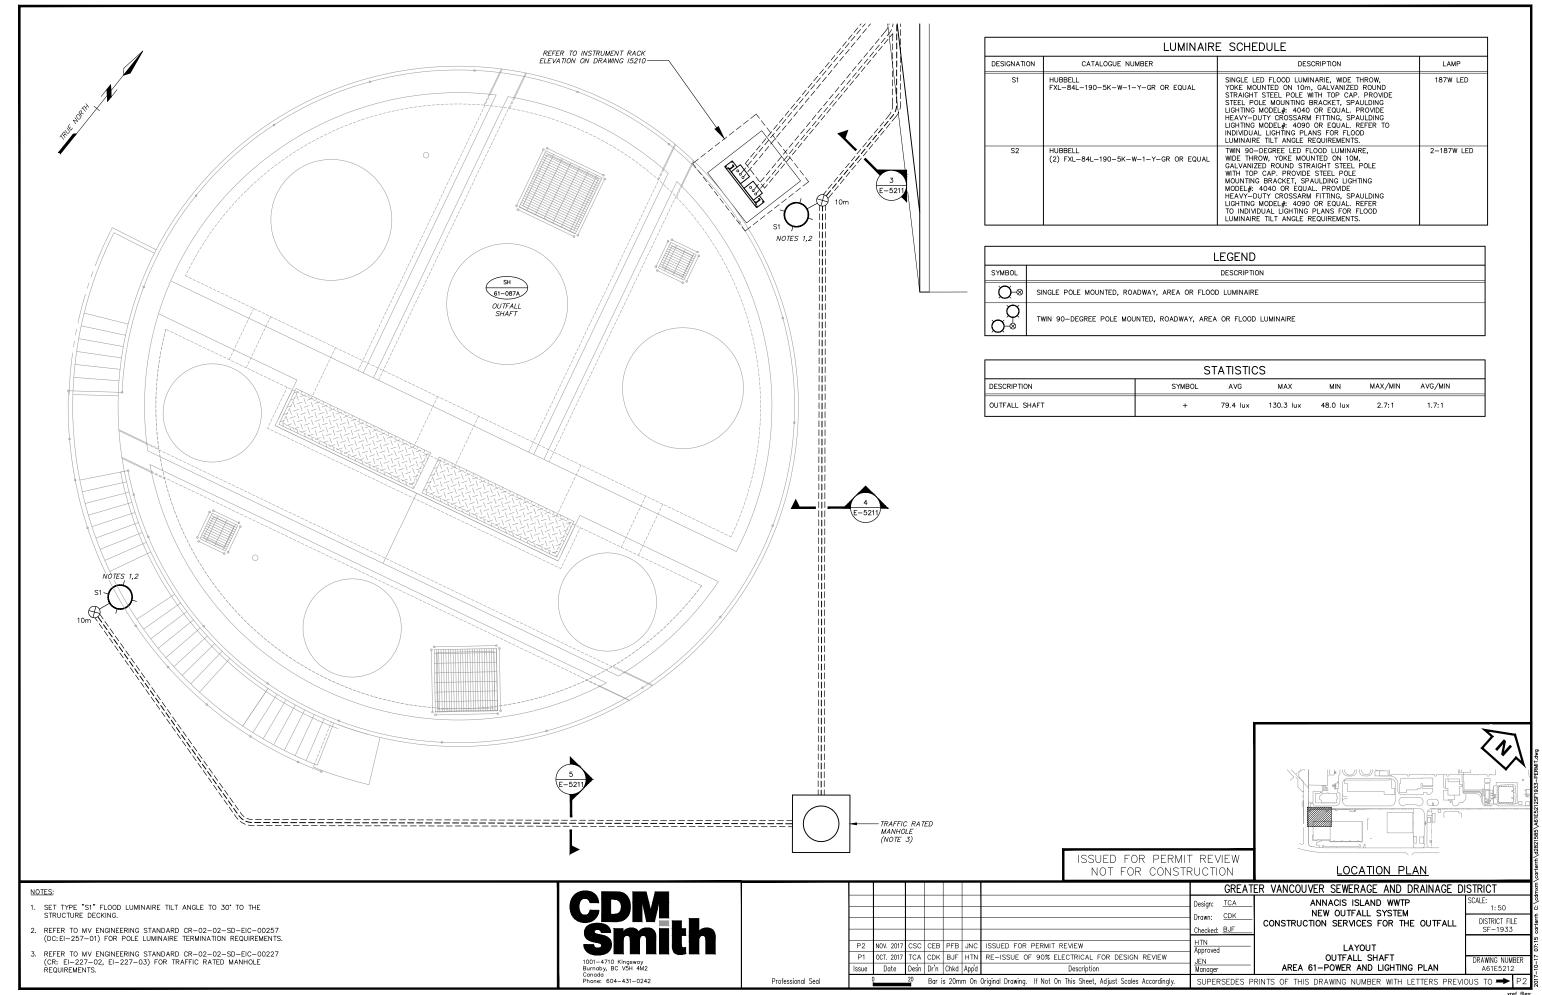

LUMINAIRE SCHEDULE					
BER	DESCRIPTION	LAMP			
'-GR OR EQUAL	SINGLE LED FLOOD LUMINARIE, WDE THROW, YOKE MOUNTED ON 10m, GALVANIZED ROUND STRAIGHT STEEL POLE WITH TOP CAP. PROVIDE STEEL POLE MOUNTING BRACKET, SPAULDING LIGHTING MODEL#: 4040 OR EQUAL. PROVIDE HEAVY-DUTY CROSSARM FITTING, SPAULDING LIGHTING MODEL#: 4090 OR EQUAL. REFER TO INDIVIDUAL LIGHTING PLANS FOR FLOOD LUMINAIRE TILT ANGLE REQUIREMENTS.	187W LED			
-1-Y-GR OR EQUAL	TWIN 90-DECREE LED FLOOD LUMINAIRE, WIDE THROW, YOKE MOUNTED ON 10M, GALVANIZED ROUND STRAIGHT STEEL POLE WITH TOP CAP. PROVDE STEEL POLE MOUNTING BRACKET, SPAULDING LIGHTING MODEL#: 4040 OR EQUAL. PROVDE HEAVY-DUTY CROSSARM FITTING, SPAULDING LIGHTING MODEL#: 4090 OR EQUAL REFER TO INDIVIDUAL LIGHTING PLANS FOR FLOOD LUMINAIRE TLT ANGLE REQUIREMENTS.	2-187W LED			

LEGEND
DESCRIPTION
WAY, AREA OR FLOOD LUMINAIRE
IED, ROADWAY, AREA OR FLOOD LUMINAIRE

	STATISTI	CS				
SYMBO	)L AVG	MAX	MIN	MAX/MIN	AVG/MIN	
+	79.4 lux	130.3 lux	48.0 lux	2.7:1	1.7:1	